Verizon

VERIZON SITE NUMBER: 307653

VERIZON SITE NAME:

SITE INFORMATION

151 OAK DRIVE,

WELD

080306000027

4818 FT (AMSL)

POULSEN LLC

EATON, CO 80634

EATON, CO 80615

FILL-IN / GREELY/GRE216

40.52268055 / 40° 31' 21.65" N

TOWN OF EATON, CO

HUMAN HABITATION

2000 CORPORATE DRIVE

CANONSBURG, PA 15317

1515 E. WOODFIELD ROAD SCHAUMBURG, IL 60173

VERIZON WIRELESS

-104.7096222 / 104° 42' 34.6399" W

FACILITY IS UNMANNED AND NOT FOR

SITE TYPE:

CROWN CASTLE USA INC.

AREA OF CONSTRUCTION:

SITE NAME:

COUNTY:

LATITUDE:

LONGITUDE:

LAT/LONG TYPE:

JURISDICTION:

GROUND ELEVATION

TYPE OF CONSTRUCTION:

CURRENT ZONING:

A.D.A. COMPLIANCE:

PROPERTY OWNER:

CARRIER/APPLICANT:

ELECTRIC PROVIDER:

TELCO PROVIDER:

SITE ADDRESS:

MAP/PARCEL #:

TOWER HEIGHT:

DT EATON - C

MONOPOLE TOWER

117'-6"

BUSINESS UNIT #: 877107

151 OAK DRIVE, SITE ADDRESS: **EATON, CO 80615**

WELD COUNTY:

TOWN OF EATON, CO JURISDICTION:

VERIZON FUZE PROJECT #: 16114261

DRAWING INDEX SHEET# SHEET DESCRIPTION TITLE SHEET GENERAL NOTES SITE PLAN COMPOUND PLAN TOWER ELEVATION & ANTENNA PLANS EQUIPMENT SCHEDULES EQUIPMENT DETAILS EQUIPMENT DETAILS DUAL-MOUNT ANTENNA BRACKET DETAIL PLUMBING DIAGRAM GROUNDING DETAILS GROUNDING DETAILS ATTACHED LEGAL DESCRIPTION

22"X34". CONTRACTOR SHALL VERIFY ALL PLANS AND AND SHALL IMMEDIATELY NOTIFY THE ENGINEER IN WRITING OF ANY DISCREPANCIES BEFORE PROCEEDING WITH THE WORK OR BE RESPONSIBLE FOR SAME.

CENTURYLINK

XCEL ENERGY

PROJECT TEAM

A&E FIRM: TRYLON

1825 W. WALNUT HILL LANE, SUITE 120

IRVING, TEXAS 75038

CROWN CASTLE

CONTACTS:

1 CITY PLACE DRIVE, SUITE 490 ST. LOUIS, MO 63141

USA INC. DISTRICT

EVE ZWEIG - PROJECT MANAGER

EVE.ZWEIG@CROWNCASTLE.COM

JONATHAN MACCONKEY - CONSTRUCTION MANAGER

https://pmi.vzwsmart.com

JONATHAN.MACCONKEY@CROWNCASTLE.COM


VERIZON CONTACT:


CONTRACTOR PMI REQUIREMENTS

PMI ACCESSED AT SMART TOOL VENDOR PROJECT NUMBER

VzW LOCATION CODE (PSLC)

*** PMI AND REQUIREMENTS ALSO EMBEDDED IN MOUNT ANALYSIS REPORT

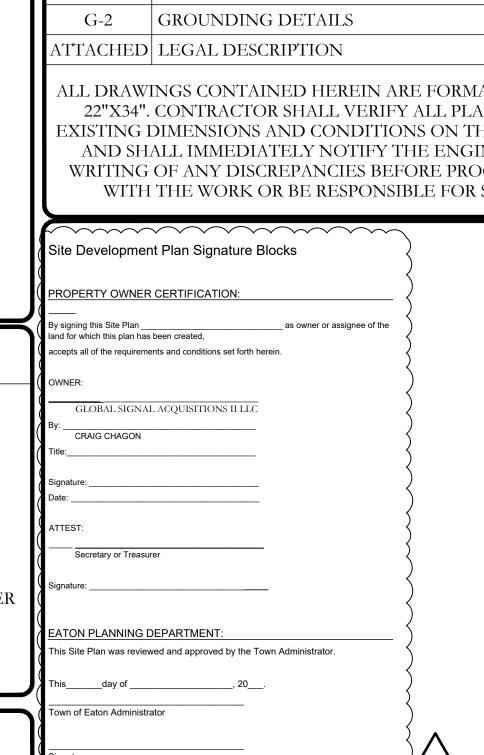

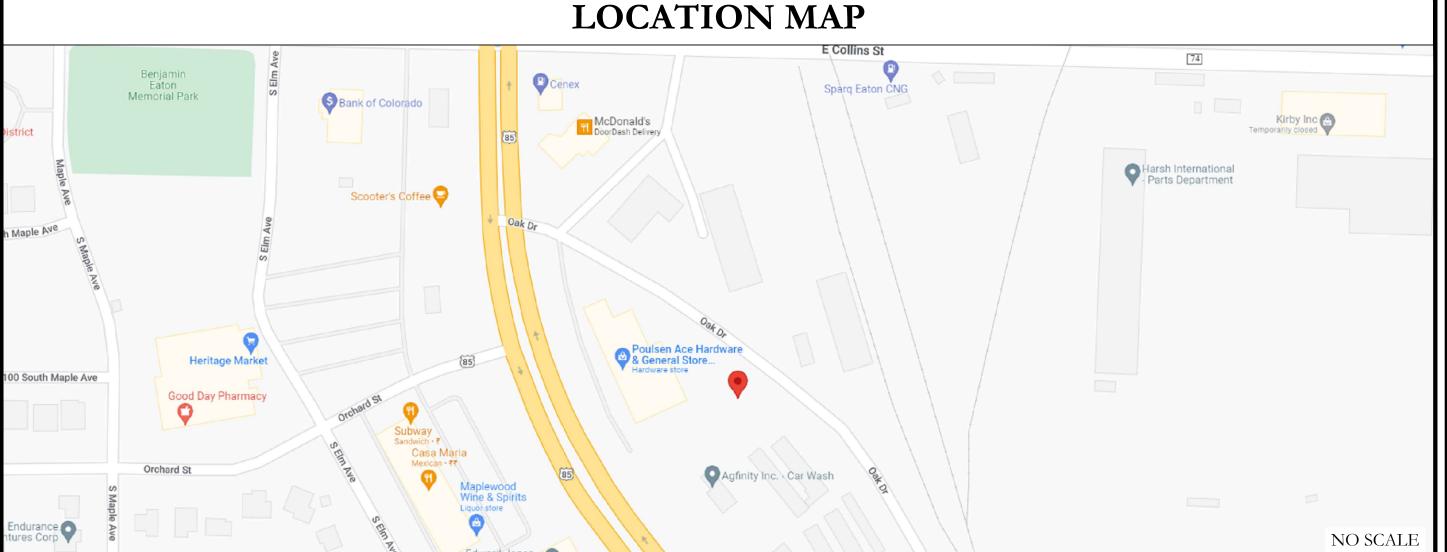

APPLICABLE CODES/REFERENCE **DOCUMENTS**

ALL WORK SHALL BE PERFORMED AND MATERIALS INSTALLED IN ACCORDANCE WITH THE CURRENT EDITIONS OF THE FOLLOWING CODES AS ADOPTED BY THE LOCAL GOVERNING AUTHORITIES. NOTHING IN THESE PLANS IS TO BE CONSTRUED TO PERMIT WORK NOT CONFORMING TO THESE CODES:

CODE TYPE CODE BUILDING 2018 IBC **MECHANICAL** 2018 IMC ELECTRICAL 2017 NEC

REFERENCE DOCUMENTS:

STRUCTURAL ANALYSIS: CROWN CASTLE

DATED: 12/23/2022 MOUNT ANALYSIS: COLLIERS ENGINEERING & DESIGN

DATED: 12/20/2022 RFDS REVISION: N/A

REVISION: 1

DATED: 12/19/2022 ORDER ID: 640675



CALL COLORADO ONE CALL CALL 3 WORKING DAYS BEFORE YOU DIG!



PROJECT DESCRIPTION

THE PURPOSE OF THIS PROJECT IS TO ENHANCE BROADBAND CONNECTIVITY AND CAPACITY TO THE EXISTING ELIGIBLE WIRELESS FACILITY.

TOWER SCOPE OF WORK:

- REMOVE (6) ANTENNAS • REMOVE (9) RRHs
- REMOVE (2) OVPs
- INSTALL (6) RRUs
- INSTALL (2) OVPs
- INSTALL (3) 12X24 HYBRID CABLES • INSTALL (3) DUAL MOUNTS

• INSTALL (9) ANTENNAS

- GROUND SCOPE OF WORK: • INSTALL (2) BBU
- INSTALL (2) OVP BOX
- PRIOR TO ACCESSING/ENTERING THE SITE YOU MUST CONTACT THE CROWN NOC AT (800) 788-7011 & CROWN CONSTRUCTION MANAGER

MOUNT MODIFICATION REQUIRED

VzW APPROVED SMART KIT VENDORS

REFER TO MOUNT MODIFICATION DRAWINGS PAGE FOR VzW SMART KIT APPROVED VENDORS







IRVING, TEXAS 75038

VERIZON SITE NUMBER: 307653

BU #: **877107** FILL-IN / GREELY/GRE216

> 151 OAK DRIVE, EATON, CO 80615

EXISTING 117'-6" MONOPOLI TOWER

	ISSUED FOR:						
REV	DATE	DRWN	DESCRIPTION	DES./QA			
0	12/30/2022	NPS	FINAL	АМТ			
1	01/04/2023	MVF	FINAL	АМТ			
2	02/28/2023	KSN	FINAL	АМТ			
3	03/30/2023	NPS	FINAL	АМТ			
4	05/15/2023	SBA	FINAL	АМТ			



IT IS A VIOLATION OF LAW FOR ANY PERSON, NLESS THEY ARE ACTING UNDER THE DIRECTION OF A LICENSED PROFESSIONAL ENGINEER, TO ALTER THIS DOCUMENT.

SHEET NUMBER:

CROWN CASTLE USA INC. SITE ACTIVITY REQUIREMENTS:

- 1. NOTICE TO PROCEED- NO WORK SHALL COMMENCE PRIOR TO CROWN CASTLE USA INC. WRITTEN NOTICE TO PROCEED (NTP) AND THE ISSUANCE OF A PURCHASE ORDER. PRIOR TO ACCESSING/ENTERING THE SITE YOU MUST CONTACT THE CROWN CASTLE USA INC. NOC AT 800-788-7011 & THE CROWN CASTLE USA INC. CONSTRUCTION MANAGER.
- "LOOK UP" CROWN CASTLE USA INC. SAFETY CLIMB REQUIREMENT
- THE INTEGRITY OF THE SAFETY CLIMB AND ALL COMPONENTS OF THE CLIMBING FACILITY SHALL BE CONSIDERED DURING ALL STAGES OF DESIGN, INSTALLATION, AND INSPECTION. TOWER MODIFICATION, MOUNT REINFORCEMENTS, AND/OR EQUIPMENT INSTALLATIONS SHALL NOT COMPROMISE THE INTEGRITY OR FUNCTIONAL USE OF THE SAFETY CLIMB OR ANY COMPONENTS OF THE CLIMBING FACILITY ON THE STRUCTURE. THIS SHALL INCLUDE, BUT NOT BE LIMITED TO: PINCHING OF THE WIRE ROPE, BENDING OF THE WIRE ROPE FROM ITS SUPPORTS, DIRECT CONTACT OR CLOSE PROXIMITY TO THE WIRE ROPE WHICH MAY CAUSE FRICTIONAL WEAR, IMPACT TO THE ANCHORAGE POINTS IN ANY WAY, OR TO IMPEDE/BLOCK ITS INTENDED USE. ANY COMPROMISED SAFETY CLIMB, INCLUDING EXISTING CONDITIONS MUST BE TAGGED OUT AND REPORTED TO YOUR CROWN CASTLE USA INC. POC OR CALL THE NOC TO GENERATE A SAFETY CLIMB MAINTENANCE AND CONTRACTOR NOTICE TICKET.
- PRIOR TO THE START OF CONSTRUCTION, ALL REQUIRED JURISDICTIONAL PERMITS SHALL BE OBTAINED. THIS INCLUDES, BUT IS NOT LIMITED TO, BUILDING, ELECTRICAL, MECHANICAL, FIRE, FLOOD ZONE, ENVIRONMENTAL, AND ZONING. AFTER ONSITE ACTIVITIES AND CONSTRUCTION ARE COMPLETED, ALL REQUIRED PERMITS SHALL BE SATISFIED AND CLOSED OUT ACCORDING TO LOCAL JURISDICTIONAL REQUIREMENTS
- ALL CONSTRUCTION MEANS AND METHODS; INCLUDING BUT NOT LIMITED TO, ERECTION PLANS, RIGGING PLANS, CLIMBING PLANS, AND RESCUE PLANS SHALL BE THE RESPONSIBILITY OF THE GENERAL CONTRACTOR RESPONSIBLE FOR THE EXECUTION OF THE WORK CONTAINED HEREIN, AND SHALL MEET ANSI/ASSE A10.48 (LATEST EDITION); FEDERAL, STATE, AND LOCAL REGULATIONS; AND ANY APPLICABLE INDUSTRY CONSENSUS STANDARDS RELATED TO THE CONSTRUCTION ACTIVITIES BEING PERFORMED. ALL RIGGING PLANS SHALL ADHERE TO ANSI/ASSE A10.48 (LATEST EDITION) AND CROWN CASTLE USA INC. STANDARD CED-STD-10253, INCLUDING THE REQUIRED INVOLVEMENT OF A QUALIFIED ENGINEER FOR CLASS IV CONSTRUCTION, TO CERTIFY THE SUPPORTING STRUCTURE(S) IN ACCORDANCE WITH ANSI/TIA-322 (LATEST EDITION)
- 5. ALL SITE WORK TO COMPLY WITH QAS-STD-10068 "INSTALLATION STANDARDS FOR CONSTRUCTION ACTIVITIES ON CROWN CASTLE USA INC. TOWER SITE," CED-STD-10294 "STANDARD FOR INSTALLATION OF MOUNTS AND APPURTENANCES," AND LATEST VERSION OF ANSI/TIA-1019-A-2012 "STANDARD FOR INSTALLATION, ALTERATION, AND MAINTENANCE OF ANTENNA SUPPORTING STRUCTURES AND ANTENNAS.
- IF THE SPECIFIED EQUIPMENT CAN NOT BE INSTALLED AS SHOWN ON THESE DRAWINGS, THE CONTRACTOR SHALL PROPOSE AN ALTERNATIVE INSTALLATION FOR APPROVAL BY CROWN CASTLE USA INC. PRIOR TO PROCEEDING WITH ANY SUCH CHANGE OF INSTALLATION.
- ALL MATERIALS FURNISHED AND INSTALLED SHALL BE IN STRICT ACCORDANCE WITH ALL APPLICABLE CODES, REGULATIONS AND ORDINANCES. CONTRACTOR SHALL ISSUE ALL APPROPRIATE NOTICES AND COMPLY WITH ALL LAWS, ORDINANCES, RULES, REGULATIONS AND LAWFUL ORDERS OF ANY PUBLIC AUTHORITY REGARDING THE PERFORMANCE OF THE WORK. ALL WORK CARRIED OUT SHALL COMPLY WITH ALL APPLICABLE MUNICIPAL AND UTILITY COMPANY SPECIFICATIONS AND LOCAL JURISDICTIONAL CODES, ORDINANCES AND APPLICABLE REGULATIONS.
- THE CONTRACTOR SHALL INSTALL ALL EQUIPMENT AND MATERIALS IN ACCORDANCE WITH MANUFACTURER'S RECOMMENDATIONS UNLESS SPECIFICALLY STATED OTHERWISE.
- THE CONTRACTOR SHALL CONTACT UTILITY LOCATING SERVICES PRIOR TO THE START OF CONSTRUCTION.
- 10. ALL EXISTING ACTIVE SEWER, WATER, GAS, ELECTRIC AND OTHER UTILITIES WHERE ENCOUNTERED IN THE WORK, SHALL BE PROTECTED AT ALL TIMES AND WHERE REQUIRED FOR THE PROPER EXECUTION OF THE WORK, SHALL BE RELOCATED AS DIRECTED BY CONTRACTOR. EXTREME CAUTION SHOULD BE USED BY THE CONTRACTOR WHEN EXCAVATING OR DRILLING PIERS AROUND OR NEAR UTILITIES. CONTRACTOR SHALL PROVIDE SAFETY TRAINING FOR THE WORKING CREW. THIS WILL INCLUDE BUT NOT BE LIMITED TO A) FALL PROTECTION B) CONFINED SPACE C) ELECTRICAL SAFETY D) TRENCHING AND EXCAVATION E) CONSTRUCTION SAFETY PROCEDURES.
- 11. ALL SITE WORK SHALL BE AS INDICATED ON THE STAMPED CONSTRUCTION DRAWINGS AND PROJECT SPECIFICATIONS, LATEST APPROVED REVISION.
- 12. CONTRACTOR SHALL KEEP THE SITE FREE FROM ACCUMULATING WASTE MATERIAL, DEBRIS, AND TRASH AT THE COMPLETION OF THE WORK. IF NECESSARY, RUBBISH, STUMPS, DEBRIS, STICKS, STONES AND OTHER REFUSE SHALL BE REMOVED FROM THE SITE AND DISPOSED OF LEGALLY
- 13. ALL EXISTING INACTIVE SEWER, WATER, GAS, ELECTRIC AND OTHER UTILITIES, WHICH INTERFERE WITH THE EXECUTION OF THE WORK, SHALL BE REMOVED AND/OR CAPPED, PLUGGED OR OTHERWISE DISCONTINUED AT POINTS WHICH WILL NOT INTERFERE WITH THE EXECUTION OF THE WORK, SUBJECT TO THE APPROVAL OF CONTRACTOR, TOWER OWNER, CROWN CASTLE USA INC., AND/OR LOCAL UTILITIES
- 14. THE CONTRACTOR SHALL PROVIDE SITE SIGNAGE IN ACCORDANCE WITH THE TECHNICAL SPECIFICATION FOR SITE SIGNAGE REQUIRED BY LOCAL JURISDICTION AND SIGNAGE REQUIRED ON INDIVIDUAL PIECES OF EQUIPMENT, ROOMS, AND SHELTERS.
- 15. THE SITE SHALL BE GRADED TO CAUSE SURFACE WATER TO FLOW AWAY FROM THE CARRIER'S EQUIPMENT AND TOWER AREAS.
- 16. THE SUB GRADE SHALL BE COMPACTED AND BROUGHT TO A SMOOTH UNIFORM GRADE PRIOR TO FINISHED JRFACE APPLICATION.
- 17. THE AREAS OF THE OWNERS PROPERTY DISTURBED BY THE WORK AND NOT COVERED BY THE TOWER, EQUIPMENT OR DRIVEWAY, SHALL BE GRADED TO A UNIFORM SLOPE, AND STABILIZED TO PREVENT EROSION AS SPECIFIED ON THE CONSTRUCTION DRAWINGS AND/OR PROJECT SPECIFICATIONS.
- 18. CONTRACTOR SHALL MINIMIZE DISTURBANCE TO EXISTING SITE DURING CONSTRUCTION. EROSION CONTROL MEASURES, IF REQUIRED DURING CONSTRUCTION, SHALL BE IN CONFORMANCE WITH THE LOCAL GUIDELINES FOR EROSION AND SEDIMENT CONTROL.
- 19. THE CONTRACTOR SHALL PROTECT EXISTING IMPROVEMENTS, PAVEMENTS, CURBS, LANDSCAPING AND STRUCTURES. ANY DAMAGED PART SHALL BE REPAIRED AT CONTRACTOR'S EXPENSE TO THE SATISFACTION
- 20. CONTRACTOR SHALL LEGALLY AND PROPERLY DISPOSE OF ALL SCRAP MATERIALS SUCH AS COAXIAL CABLES AND OTHER ITEMS REMOVED FROM THE EXISTING FACILITY. ANTENNAS REMOVED SHALL BE RETURNED TO THE OWNER'S DESIGNATED LOCATION.
- 21. CONTRACTOR SHALL LEAVE PREMISES IN CLEAN CONDITION. TRASH AND DEBRIS SHOULD BE REMOVED FROM SITE ON A DAILY BASIS.
- 22. NO FILL OR EMBANKMENT MATERIAL SHALL BE PLACED ON FROZEN GROUND. FROZEN MATERIALS, SNOW OR ICE SHALL NOT BE PLACED IN ANY FILL OR EMBANKMENT.

GENERAL NOTES:

- FOR THE PURPOSE OF CONSTRUCTION DRAWING, THE FOLLOWING DEFINITIONS SHALL APPLY: GENERAL CONTRACTOR RESPONSIBLE FOR CONSTRUCTION CONTRACTOR:
- CARRIER: VERIZON TOWER OWNER: CROWN CASTLE USA INC.
- 2. THESE DRAWINGS HAVE BEEN PREPARED USING STANDARDS OF PROFESSIONAL CARE AND COMPLETENESS NORMALLY EXERCISED UNDER SIMILAR CIRCUMSTANCES BY REPUTABLE ENGINEERS IN THIS OR SIMILAR LOCALITIES. IT IS ASSUMED THAT THE WORK DEPICTED WILL BE PERFORMED BY AN EXPERIENCED CONTRACTOR AND/OR WORKPEOPLE WHO HAVE A WORKING KNOWLEDGE OF THE APPLICABLE CODE STANDARDS AND REQUIREMENTS AND OF INDUSTRY ACCEPTED STANDARD GOOD PRACTICE. AS NOT EVERY CONDITION OR ELEMENT IS (OR CAN BE) EXPLICITLY SHOWN ON THESE DRAWINGS, THE CONTRACTOR SHALL USE INDUSTRY ACCEPTED STANDARD GOOD PRACTICE FOR MISCELLANEOUS WORK NOT EXPLICITLY SHOWN.
- THESE DRAWINGS REPRESENT THE FINISHED STRUCTURE. THEY DO NOT INDICATE THE MEANS OR METHODS OF CONSTRUCTION. THE CONTRACTOR SHALL BE SOLELY RESPONSIBLE FOR THE CONSTRUCTION MEANS, METHODS TECHNIQUES, SEQUENCES, AND PROCEDURES. THE CONTRACTOR SHALL PROVIDE ALL MEASURES NECESSARY FOR PROTECTION OF LIFE AND PROPERTY DURING CONSTRUCTION. SUCH MEASURES SHALL INCLUDE, BUT NOT BE LIMITED TO, BRACING, FORMWORK, SHORING, ETC. SITE VISITS BY THE ENGINEER OR HIS REPRESENTATIVE WILL NOT INCLUDE INSPECTION OF THESE ITEMS AND IS FOR STRUCTURAL OBSERVATION OF THE FINISHED STRUCTURE ONLY.
- NOTES AND DETAILS IN THE CONSTRUCTION DRAWINGS SHALL TAKE PRECEDENCE OVER GENERAL NOTES AND TYPICAL DETAILS. WHERE NO DETAILS ARE SHOWN, CONSTRUCTION SHALL CONFORM TO SIMILAR WORK ON THE PROJECT, AND/OR AS PROVIDED FOR IN THE CONTRACT DOCUMENTS. WHERE DISCREPANCIES OCCUR BETWEEN PLANS, DETAILS, GENERAL NOTES, AND SPECIFICATIONS, THE GREATER, MORE STRICT REQUIREMENTS, SHALL GOVERN. IF FURTHER CLARIFICATION IS REQUIRED CONTACT THE ENGINEER OF RECORD.
- SUBSTANTIAL EFFORT HAS BEEN MADE TO PROVIDE ACCURATE DIMENSI<mark>ONS AND MEASUREMENTS ON</mark> THE DRAWINGS TO ASSIST IN THE FABRICATION AND/OR PLACEMENT OF CONSTRUCTION ELEMENTS BUT IT IS THE SOLE RESPONSIBILITY OF THE CONTRACTOR TO FIELD VERIFY THE DIMENSIONS, MEASUREMENTS, AND/OR CLEARANCES SHOWN IN THE CONSTRUCTION DRAWINGS PRIOR TO FABRICATION OR CUTTING OF ANY NEW OR EXISTING CONSTRUCTION ELEMENTS. IF IT IS DETERMINED THAT THERE ARE DISCREPANCIES AND/OR CONFLICTS WITH THE CONSTRUCTION DRAWINGS THE ENGINEER OF RECORD IS TO BE NOTIFIED AS SOON AS POSSIBLE.
- PRIOR TO THE SUBMISSION OF BIDS, THE BIDDING CONTRACTOR SHALL VISIT THE CELL SITE TO FAMILIARIZE WITH THE EXISTING CONDITIONS AND TO CONFIRM THAT THE WORK CAN BE ACCOMPLISHED AS SHOWN ON THE CONSTRUCTION DRAWINGS. ANY DISCREPANCY FOUND SHALL BE BROUGHT TO THE ATTENTION OF CROWN CASTLE
- ALL MATERIALS FURNISHED AND INSTALLED SHALL BE IN STRICT ACCORDANCE WITH ALL APPLICABLE CODES, REGULATIONS AND ORDINANCES. CONTRACTOR SHALL ISSUE ALL APPROPRIATE NOTICES AND COMPLY WITH ALL LAWS, ORDINANCES, RULES, REGULATIONS AND LAWFUL ORDERS OF ANY PUBLIC AUTHORITY REGARDING THE PERFORMANCE OF THE WORK. ALL WORK CARRIED OUT SHALL COMPLY WITH ALL APPLICABLE MUNICIPAL AND UTILITY COMPANY SPECIFICATIONS AND LOCAL JURISDICTIONAL CODES, ORDINANCES AND APPLICABLE REGULATIONS.
- UNLESS NOTED OTHERWISE, THE WORK SHALL INCLUDE FURNISHING MATERIALS, EQUIPMENT, APPURTENANCES AND LABOR NECESSARY TO COMPLETE ALL INSTALLATIONS AS INDICATED ON THE DRAWINGS.
- THE CONTRACTOR SHALL INSTALL ALL EQUIPMENT AND MATERIALS IN ACCORDANCE WITH MANUFACTURER'S RECOMMENDATIONS UNLESS SPECIFICALLY STATED OTHERWISE.
- 10. IF THE SPECIFIED EQUIPMENT CAN NOT BE INSTALLED AS SHOWN ON THESE DRAWINGS, THE CONTRACTOR SHALL PROPOSE AN ALTERNATIVE INSTALLATION FOR APPROVAL BY THE CARRIER AND CROWN CASTLE PRIOR TO PROCEEDING
- WITH ANY SUCH CHANGE OF INSTALLATION. 11. CONTRACTOR IS TO PERFORM A SITE INVESTIGATION AND IS TO DETERMINE THE BEST ROUTING OF ALL CONDUITS FOR POWER, AND TELCO AND FOR GROUNDING CABLES AS SHOWN IN THE POWER, TELCO, AND GROUNDING PLAN
- DRAWINGS 12. THE CONTRACTOR SHALL PROTECT EXISTING IMPROVEMENTS, PAVEMENTS, CURBS, LANDSCAPING AND STRUCTURES. ANY
- DAMAGED PART SHALL BE REPAIRED AT CONTRACTOR'S EXPENSE TO THE SATISFACTION OF CROWN CASTLE USA INC. 13. CONTRACTOR SHALL LEGALLY AND PROPERLY DISPOSE OF ALL SCRAP MATERIALS SUCH AS COAXIAL CABLES AND OTHER ITEMS REMOVED FROM THE EXISTING FACILITY. ANTENNAS REMOVED SHALL BE RETURNED TO THE OWNER'S DESIGNATED LOCATION.
- 14. CONTRACTOR SHALL LEAVE PREMISES IN CLEAN CONDITION. TRASH AND DEBRIS SHOULD BE REMOVED FROM SITE ON A DAILY BASIS.

CONCRETE, FOUNDATIONS, AND REINFORCING STEEL:

- ALL CONCRETE WORK SHALL BE IN ACCORDANCE WITH THE ACI 301, ACI 318, ACI 336, ASTM A184, ASTM A185 AND THE DESIGN AND CONSTRUCTION SPECIFICATION FOR CAST-IN-PLACE CONCRETE. 2. UNLESS NOTED OTHERWISE, SOIL BEARING PRESSURE USED FOR DESIGN OF SLABS AND FOUNDATIONS IS ASSUMED
- TO BE 1000 psf. 3. ALL CONCRETE SHALL HAVE A MINIMUM COMPRESSIVE STRENGTH (f'c) OF 3000 psi AT 28 DAYS, UNLESS NOTED OTHERWISE. NO MORE THAN 90 MINUTES SHALL ELAPSE FROM BATCH TIME TO TIME OF PLACEMENT UNLESS APPROVED BY THE ENGINEER OF RECORD. TEMPERATURE OF CONCRETE SHALL NOT EXCEED 90°f AT TIME OF
- CONCRETE EXPOSED TO FREEZE-THAW CYCLES SHALL CONTAIN AIR ENTRAINING ADMIXTURES. AMOUNT OF AIR ENTRAINMENT TO BE BASED ON SIZE OF AGGREGATE AND F3 CLASS EXPOSURE (VERY SEVERE). CEMENT USED TO BE TYPE II PORTLAND CEMENT WITH A MAXIMUM WATER-TO-CEMENT RATIO (W/C) OF 0.45.
- ALL STEEL REINFORCING SHALL CONFORM TO ASTM A615. ALL WELDED WIRE FABRIC (WWF) SHALL CONFORM TO ASTM A185. ALL SPLICES SHALL BE CLASS "B" TENSION SPLICES, UNLESS NOTED OTHERWISE. ALL HOOKS SHALL BE STANDARD 90 DEGREE HOOKS, UNLESS NOTED OTHERWISE. YIELD STRENGTH (Fy) OF STANDARD DEFORMED BARS ARE AS FOLLOWS:
- #4 BARS AND SMALLER.... #5 BARS AND LARGER.... ..60 ksi
- THE FOLLOWING MINIMUM CONCRETE COVER SHALL BE PROVIDED FOR REINFORCING STEEL UNLESS SHOWN OTHERWISE ON DRAWINGS:
- CONCRETE CAST AGAINST AND PERMANENTLY EXPOSED TO EARTH... CONCRETE EXPOSED TO EARTH OR WEATHER:

OTHERWISE, IN ACCORDANCE WITH ACI 301 SECTION 4.2.4.

- #6 BARS AND LARGER ... #5 BARS AND SMALLER1-1/2" CONCRETE NOT EXPOSED TO EARTH OR WEATHER:
- SLAB AND WALLS.... BEAMS AND COLUMNS .. 7. A TOOLED EDGE OR A 3/4" CHAMFER SHALL BE PROVIDED AT ALL EXPOSED EDGES OF CONCRETE, UNLESS NOTED

GREENFIELD GROUNDING NOTES:

- ALL GROUND ELECTRODE SYSTEMS (INCLUDING TELECOMMUNICATION, RADIO, LIGHTNING PROTECTION AND AC POWER GES'S) SHALL BE BONDED TOGETHER AT OR BELOW GRADE, BY TWO OR MORE COPPER BONDING CONDUCTORS IN ACCORDANCE WITH THE NEC.
- THE CONTRACTOR SHALL PERFORM IEEE FALL—OF—POTENTAL RESISTANCE TO EARTH TESTING (PER IEEE 1100 AND 81) FOR GROUND ELECTRODE SYSTEMS, THE CONTRACTOR SHALL FURNISH AND INSTALL SUPPLEMENTAL GROUND ELECTRODES AS NEEDED TO ACHIEVE A TEST RESULT OF 5 OHMS OR LESS
- THE CONTRACTOR IS RESPONSIBLE FOR PROPERLY SEQUENCING GROUNDING AND UNDERGROUND CONDUIT INSTALLATION AS TO PREVENT ANY LOSS OF CONTINUITY IN THE GROUNDING SYSTEM OR DAMAGE TO THE CONDUIT AND PROVIDE
- 4. METAL CONDUIT AND TRAY SHALL BE GROUNDED AND MADE ELECTRICALLY CONTINUOUS WITH LISTED BONDING FITTINGS OR BY BONDING ACROSS THE DISCONTINUITY WITH #6 COPPER WIRE UL APPROVED GROUNDING TYPE CONDUIT CLAMPS
- METAL RACEWAY SHALL NOT BE USED AS THE NEC REQUIRED EQUIPMENT GROUND CONDUCTOR. STRANDED COPPER CONDUCTORS WITH GREEN INSULATION, SIZED IN ACCORDANCE WITH THE NEC, SHALL BE FURNISHED AND INSTALLED WITH THE POWER CIRCUITS TO BTS EQUIPMENT.
- EACH CABINET FRAME SHALL BE DIRECTLY CONNECTED TO THE MASTER GROUND BAR WITH GREEN INSULATED SUPPLEMENTAL EQUIPMENT GROUND WIRES, #6 STRANDED COPPER OR LARGER FOR INDOOR BTS; #2 BARE SOLID TINNED COPPER FOR OUTDOOR BTS.
- CONNECTIONS TO THE GROUND BUS SHALL NOT BE DOUBLED UP OR STACKED BACK TO BACK CONNECTIONS ON OPPOSITE SIDE OF THE GROUND BUS ARE PERMITTED.
- ALL EXTERIOR GROUND CONDUCTORS BETWEEN EQUIPMENT/GROUND BARS AND THE GROUND RING SHALL BE #2 SOLID TINNED COPPER UNLESS OTHERWISE INDICATED. ALUMINUM CONDUCTOR OR COPPER CLAD STEEL CONDUCTOR SHALL NOT BE USED FOR GROUNDING CONNECTIONS.
- USE OF 90° BENDS IN THE PROTECTION GROUNDING CONDUCTORS SHALL BE AVOIDED WHEN 45° BENDS CAN BE ADEQUATELY SUPPORTED.
- 11. EXOTHERMIC WELDS SHALL BE USED FOR ALL GROUNDING CONNECTIONS BELOW GRADE.
- 12. ALL GROUND CONNECTIONS ABOVE GRADE (INTERIOR AND EXTERIOR) SHALL BE FORMED USING HIGH PRESS CRIMPS. 13. COMPRESSION GROUND CONNECTIONS MAY BE REPLACED BY EXOTHERMIC WELD CONNECTIONS.
- 14. ICE BRIDGE BONDING CONDUCTORS SHALL BE EXOTHERMICALLY BONDED OR BOLTED TO THE BRIDGE AND THE TOWER GROUND BAR.
- 15. APPROVED ANTIOXIDANT COATINGS (i.e. CONDUCTIVE GEL OR PASTE) SHALL BE USED ON ALL COMPRESSION AND BOLTED GROUND CONNECTIONS. 16. ALL EXTERIOR GROUND CONNECTIONS SHALL BE COATED WITH A CORROSION RESISTANT MATERIAL.
- 17. MISCELLANEOUS ELECTRICAL AND NON-ELECTRICAL METAL BOXES, FRAMES AND SUPPORTS SHALL BE BONDED TO THE GROUND RING, IN ACCORDANCE WITH THE NEC.
- 18. BOND ALL METALLIC OBJECTS WITHIN 6 ft OF MAIN GROUND RING WITH (1) #2 BARE SOLID TINNED COPPER GROUND CONDUCTOR.
- 19. GROUND CONDUCTORS USED FOR THE FACILITY GROUNDING AND LIGHTNING PROTECTION SYSTEMS SHALL NOT BE ROUTED THROUGH METALLIC OBJECTS THAT FORM A RING AROUND THE CONDUCTOR, SUCH AS METALLIC CONDUITS, METAL SUPPORT CLIPS OR SLEEVES THROUGH WALLS OR FLOORS. WHEN IT IS REQUIRED TO BE HOUSED IN CONDUIT TO MEET CODE REQUIREMENTS OR LOCAL CONDITIONS, NON-METALLIC MATERIAL SUCH AS PVC CONDUIT SHALL BE USED. WHERE USE OF METAL CONDUIT IS UNAVOIDABLE (i.e., NONMETALLIC CONDUIT PROHIBITED BY LOCAL CODE) THE GROUND CONDUCTOR SHALL BE BONDED TO EACH END OF THE METAL CONDUIT
- 20. ALL GROUNDS THAT TRANSITION FROM BELOW GRADE TO ABOVE GRADE MUST BE #2 BARE SOLID TINNED COPPER IN 3/4" NON-METALLIC, FLEXIBLE CONDUIT FROM 24" BELOW GRADE TO WITHIN 3" TO 6" OF CAD-WELD TERMINATION POINT. THE EXPOSED END OF THE CONDUIT MUST BE SEALED WITH SILICONE CAULK. (ADD TRANSITIONING GROUND STANDARD DETAIL AS WELL).
- 21. BUILDINGS WHERE THE MAIN GROUNDING CONDUCTORS ARE REQUIRED TO BE ROUTED TO GRADE, THE CONTRACTOR SHALL ROUTE TWO GROUNDING CONDUCTORS FROM THE ROOFTOP, TOWERS, AND WATER TOWERS GROUNDING RING, TO THE EXISTING GROUNDING SYSTEM, THE GROUNDING CONDUCTORS SHALL NOT BE SMALLER THAN 2/0 COPPER. ROOFTOP GROUNDING RING SHALL BE BONDED TO THE EXISTING GROUNDING SYSTEM, THE BUILDING STEEL COLUMNS, LIGHTNING PROTECTION SYSTEM, AND BUILDING MAIN WATER LINE (FERROUS OR NONFERROUS METAL PIPING ONLY).

ELECTRICAL INSTALLATION NOTES:

- ALL ELECTRICAL WORK SHALL BE PERFORMED IN ACCORDANCE WITH THE PROJECT SPECIFICATIONS, NEC AND ALL APPLICABLE FEDERAL, STATE, AND LOCAL CODES/ORDINANCES.
- CONDUIT ROUTINGS ARE SCHEMATIC. CONTRACTOR SHALL INSTALL CONDUITS SO THAT ACCESS TO EQUIPMENT IS NOT BLOCKED
- AND TRIP HAZARDS ARE ELIMINATED. 3. WIRING, RACEWAY AND SUPPORT METHODS AND MATERIALS SHALL COMPLY WITH THE REQUIREMENTS OF THE NEC.
- 4. ALL CIRCUITS SHALL BE SEGREGATED AND MAINTAIN MINIMUM CABLE SEPARATION AS REQUIRED BY THE NEC.
- 4.1. ALL EQUIPMENT SHALL BEAR THE UNDERWRITERS LABORATORIES LABEL OF APPROVAL, AND SHALL CONFORM TO REQUIREMENT OF THE NATIONAL ELECTRICAL CODE.
 - ALL OVERCURRENT DEVICES SHALL HAVE AN INTERRUPTING CURRENT RATING THAT SHALL BE GREATER THAN THE SHORT CIRCUIT CURRENT TO WHICH THEY ARE SUBJECTED, 22,000 AIC MINIMUM. VERYIFY AVAILABLE SHORT CIRCUIT CURRENT DOES NOT EXCEED THE RATING OF ELECTRICAL EQUIPMENT IN ACCORDANCE WITH ARTICLE 110.24 NEC OR THE MOST CURRENT ADOPTED CODE PRE THE GOVERNING JURISDICTION.
- EACH END OF EVERY POWER PHASE CONDUCTOR, GROUNDING CONDUCTOR, AND TELCO CONDUCTOR OR CABLE SHALL BE LABELED WITH COLOR-CODED INSULATION OR ELECTRICAL TAPE (3M BRAND, 1/2" PLASTIC ELECTRICAL TAPE WITH UV PROTECTION, OR EQUAL). THE IDENTIFICATION METHOD SHALL CONFORM WITH NEC AND OSHA.
- ALL ELECTRICAL COMPONENTS SHALL BE CLEARLY LABELED WITH LAMICOID TAGS SHOWING THEIR RATED VOLTAGE, PHASE CONFIGURATION, WIRE CONFIGURATION, POWER OR AMPACITY RATING AND BRANCH CIRCUIT ID NUMBERS (i.e. PANEL BOARD AND CIRCUIT ID'S).
- PANEL BOARDS (ID NUMBERS) SHALL BE CLEARLY LABELED WITH PLASTIC LABELS 8. ALL TIE WRAPS SHALL BE CUT FLUSH WITH APPROVED CUTTING TOOL TO REMOVE SHARP EDGES.
- ALL POWER AND EQUIPMENT GROUND WIRING IN TUBING OR CONDUIT SHALL BE SINGLE COPPER CONDUCTOR (#14 OR LARGER) WITH TYPE THHW, THWN, THWN-2, XHHW, XHHW-2, THW, THW-2, RHW, OR RHW-2 INSULATION UNLESS OTHERWISE SPECIFIED.
- 10. SUPPLEMENTAL EQUIPMENT GROUND WIRING LOCATED INDOORS SHALL BE SINGLE COPPER CONDUCTOR (#6 OR LARGER) WITH
- TYPE THHW, THWN, THWN-2, XHHW, XHHW-2, THW, THW-2, RHW, OR RHW-2 INSULATION UNLESS OTHËRWISE SPECIFIÉD. 11. POWER AND CONTROL WIRING IN FLEXIBLE CORD SHALL BE MULTI-CONDUCTOR, TYPE SOOW CORD (#14 OR LARGER) UNLESS
- OTHERWISE SPECIFIED. 12. POWER AND CONTROL WIRING FOR USE IN CABLE TRAY SHALL BE MULTI-CONDUCTOR, TYPE TO CABLE (#14 OR LARGER), WITH
- TYPE THHW, THWN, THWN-2, XHHW, XHHW-2, THW, THW-2, RHW, OR RHW-2 INSULATION UNLESS OTHERWISE SPECIFIED. 13. ALL POWER AND GROUNDING CONNECTIONS SHALL BE CRIMP—STYLE, COMPRESSION WIRE LUGS AND WIRE NUTS BY THOMAS AND BETTS (OR EQUAL). LUGS AND WIRE NUTS SHALL BE RATED FOR OPERATION NOT LESS THAN 75° C (90° C IF AVAILABLE).
- 14. RACEWAY AND CABLE TRAY SHALL BE LISTED OR LABELED FOR ELECTRICAL USE IN ACCORDANCE WITH NEMA, UL, ANSI/IEEE
- 15. ELECTRICAL METALLIC TUBING (EMT), INTERMEDIATE METAL CONDUIT (IMC), OR RIGID METAL CONDUIT (RMC) SHALL BE USED FOR EXPOSED INDOOR LOCATIONS
- 16. ELECTRICAL METALLIC TUBING (EMT) OR METAL—CLAD CABLE (MC) SHALL BE USED FOR CONCEALED INDOOR LOCATIONS. 17. SCHEDULE 40 PVC UNDERGROUND ON STRAIGHTS AND SCHEDULE 80 PVC FOR ALL ELBOWS/90s AND ALL APPROVED ABOVE
- GRADE PVC CONDUIT
- 18. LIQUID-TIGHT FLEXIBLE METALLIC CONDUIT (LIQUID-TITE FLEX) SHALL BE USED INDOORS AND OUTDOORS, WHERE VIBRATION OCCURS OR FLEXIBILITY IS NEEDED.
- 19. CONDUIT AND TUBING FITTINGS SHALL BE THREADED OR COMPRESSION-TYPE AND APPROVED FOR THE LOCATION USED. SET SCREW FITTINGS ARE NOT ACCEPTABLE.
- 20. CABINETS, BOXES AND WIRE WAYS SHALL BE LABELED FOR ELECTRICAL USE IN ACCORDANCE WITH NEMA, UL, ANSI/IEEE AND
- 21. WIREWAYS SHALL BE METAL WITH AN ENAMEL FINISH AND INCLUDE A HINGED COVER, DESIGNED TO SWING OPEN DOWNWARDS (WIREMOLD SPECMATE WIREWAY).
- 22. SLOTTED WIRING DUCT SHALL BE PVC AND INCLUDE COVER (PANDUIT TYPE E OR EQUAL).
- 23. CONDUITS SHALL BE FASTENED SECURELY IN PLACE WITH APPROVED NON-PERFORATED STRAPS AND HANGERS. EXPLOSIVE DEVICES (i.e. POWDER-ACTUATED) FOR ATTACHING HANGERS TO STRUCTURE WILL NOT BE PERMITTED. CLOSELY FOLLOW THE LINES OF THE STRUCTURE, MAINTAIN CLOSE PROXIMITY TO THE STRUCTURE AND KEEP CONDUITS IN TIGHT ENVELOPES. CHANGES IN DIRECTION TO ROUTE AROUND OBSTACLES SHALL BE MADE WITH CONDUIT OUTLET BODIES. CONDUIT SHALL BE INSTALLED IN A NEAT AND WORKMANLIKE MANNER. PARALLEL AND PERPENDICULAR TO STRUCTURE WALL AND CEILING LINES. ALL CONDUIT SHALL BE FISHED TO CLEAR OBSTRUCTIONS. ENDS OF CONDUITS SHALL BE TEMPORARILY CAPPED FLUSH TO FINISH GRADE TO PREVENT CONCRETE, PLASTER OR DIRT FROM ENTERING. CONDUITS SHALL BE RIGIDLY CLAMPED TO BOXES BY GALVANIZED
- MALLEABLE IRON BUSHING ON INSIDE AND GALVANIZED MALLEABLE IRON LOCKNUT ON OUTSIDE AND INSIDE 24. EQUIPMENT CABINETS, TERMINAL BOXES, JUNCTION BOXES AND PULL BOXES SHALL BE GALVANIZED OR EPOXY-COATED SHEET STEEL. SHALL MEET OR EXCEED UL 50 AND BE RATED NEMA 1 (OR BETTER) FOR INTERIOR LOCATIONS AND NEMA 3R (OR
- METAL RECEPTACLE, SWITCH AND DEVICE BOXES SHALL BE GALVANIZED, EPOXY-COATED OR NON-CORRODING; SHALL MEET OR EXCEED UL 514A AND NEMA OS 1 AND BE RATED NEMA 1 (OR BETTER) FOR INTERIOR LOCATIONS AND WEATHER PROTECTED (WP OR BETTER) FOR EXTERIOR LOCATIONS.
- 26. NONMETALLIC RECEPTACLE, SWITCH AND DEVICE BOXES SHALL MEET OR EXCEED NEMA OS 2 (NEWEST REVISION) AND BE RATED
- NEMA 1 (OR BETTER) FOR INTERIOR LOCATIONS AND WEATHER PROTECTED (WP OR BETTER) FOR EXTERIOR LOCATIONS. 27. THE CONTRACTOR SHALL NOTIFY AND OBTAIN NECESSARY AUTHORIZATION FROM THE CARRIER AND/OR CROWN CASTLE USA INC BEFORE COMMENCING WORK ON THE AC POWER DISTRIBUTION PANELS.
- 28. THE CONTRACTOR SHALL PROVIDE NECESSARY TAGGING ON THE BREAKERS, CABLES AND DISTRIBUTION PANELS IN ACCORDANCE WITH THE APPLICABLE CODES AND STANDARDS TO SAFEGUARD LIFE AND PROPERTY.
- 29. INSTALL LAMICOID LABEL ON THE METER CENTER TO SHOW "VERIZON". 30. ALL EMPTY/SPARE CONDUITS THAT ARE INSTALLED ARE TO HAVE A METERED MULE TAPE PULL CORD INSTALLED.

CONDUCTOR COLOR CODE						
SYSTEM	CONDUCTOR	COLOR				
	A PHASE	BLACK				
 120/240V, 1Ø	B PHASE	RED				
120/2400, 10	NEUTRAL	WHITE				
	GROUND	GREEN				
	A PHASE	BLACK				
	B PHASE	RED				
120/208V, 3Ø	C PHASE	BLUE				
	NEUTRAL	WHITE				
	GROUND	GREEN				
	A PHASE	BROWN				
	B PHASE	ORANGE OR PURPLE				
277/480V, 3Ø	C PHASE	YELLOW				
	NEUTRAL	GREY				
	GROUND	GREEN				
DC VOLTAGE	POS (+)	RED**				
DC VOLIAGE	NEG (-)	BLACK**				

* SEE NEC 210.5(C)(1) AND (2) ** POLARITY MARKED AT TERMINATION

FACILITY INTERFACE FRAME

LONG TERM EVOLUTION

NATIONAL ELECTRIC CODE

MASTER GROUND BAR

RADIO BASE STATION

REMOTE RADIO HEAD

REMOTE RADIO UNIT

REMOTE ELECTRIC TILT

RADIO FREQUENCY DATA SHEET

SMART INTEGRATED DEVICE

TOWER MOUNTED AMPLIFIER

UNIVERSAL MOBILE TELECOMMUNICATIONS SYSTEM

GLOBAL POSITIONING SYSTEM

GLOBAL SYSTEM FOR MOBILE

ABBREVIATIONS:

GEN

GPS

GSM

MGB

MW

NEC

QTY

RBS

RET

RFDS

RRU

SIAD

TMA

TYP

UMTS

W.P.

RECT

ANTENNA

EXISTING

GENERATOR

MICROWAVE

PROPOSED

QUANTITY

RECTIFIER

TYPICAL

WORK POINT

POWER PLANT

LECTRIC POWER LINES, CABLES,

CONDUIT, AND LIGHTING CABLES GAS, OIL, STEAM, PETROLEUM, OR

COMMUNICATION, ALARM OR SIGNAL LINES, CABLES, OR CONDUIT AND TRAFFIC LOOPS

ECLAIMED WATER, IRRIGATION, AND SLURRY LINES

EMPORARY SURVEY MARKINGS

PROPOSED EXCAVATION

APWA UNIFORM COLOR CODE:

GASEOUS MATERIALS

POTABLE WATER

SEWERS AND DRAIN LINES



SCHAUMBURG, IL 60173



ST. LOUIS, MO 63141



1825 W. WALNUT HILL LANE, SUITE 120 IRVING, TEXAS 75038

VERIZON SITE NUMBER: 307653

BU #: **877107** FILL-IN / GREELY/GRE216

> 151 OAK DRIVE, EATON, CO 80615


EXISTING 117'-6" MONOPOL TOWER

			ISSUI	ED FOR:	
	REV	DATE	DRWN	DESCRIPTION	DES./Q
ı	0	12/30/2022	NPS	FINAL	AMT
ı	1	01/04/2023	MVF	FINAL	AMT
	2	02/28/2023	KSN	FINAL	AMT
	3	03/30/2023	NPS	FINAL	AMT
:	4	05/15/2023	SBA	FINAL	AMT
	200				



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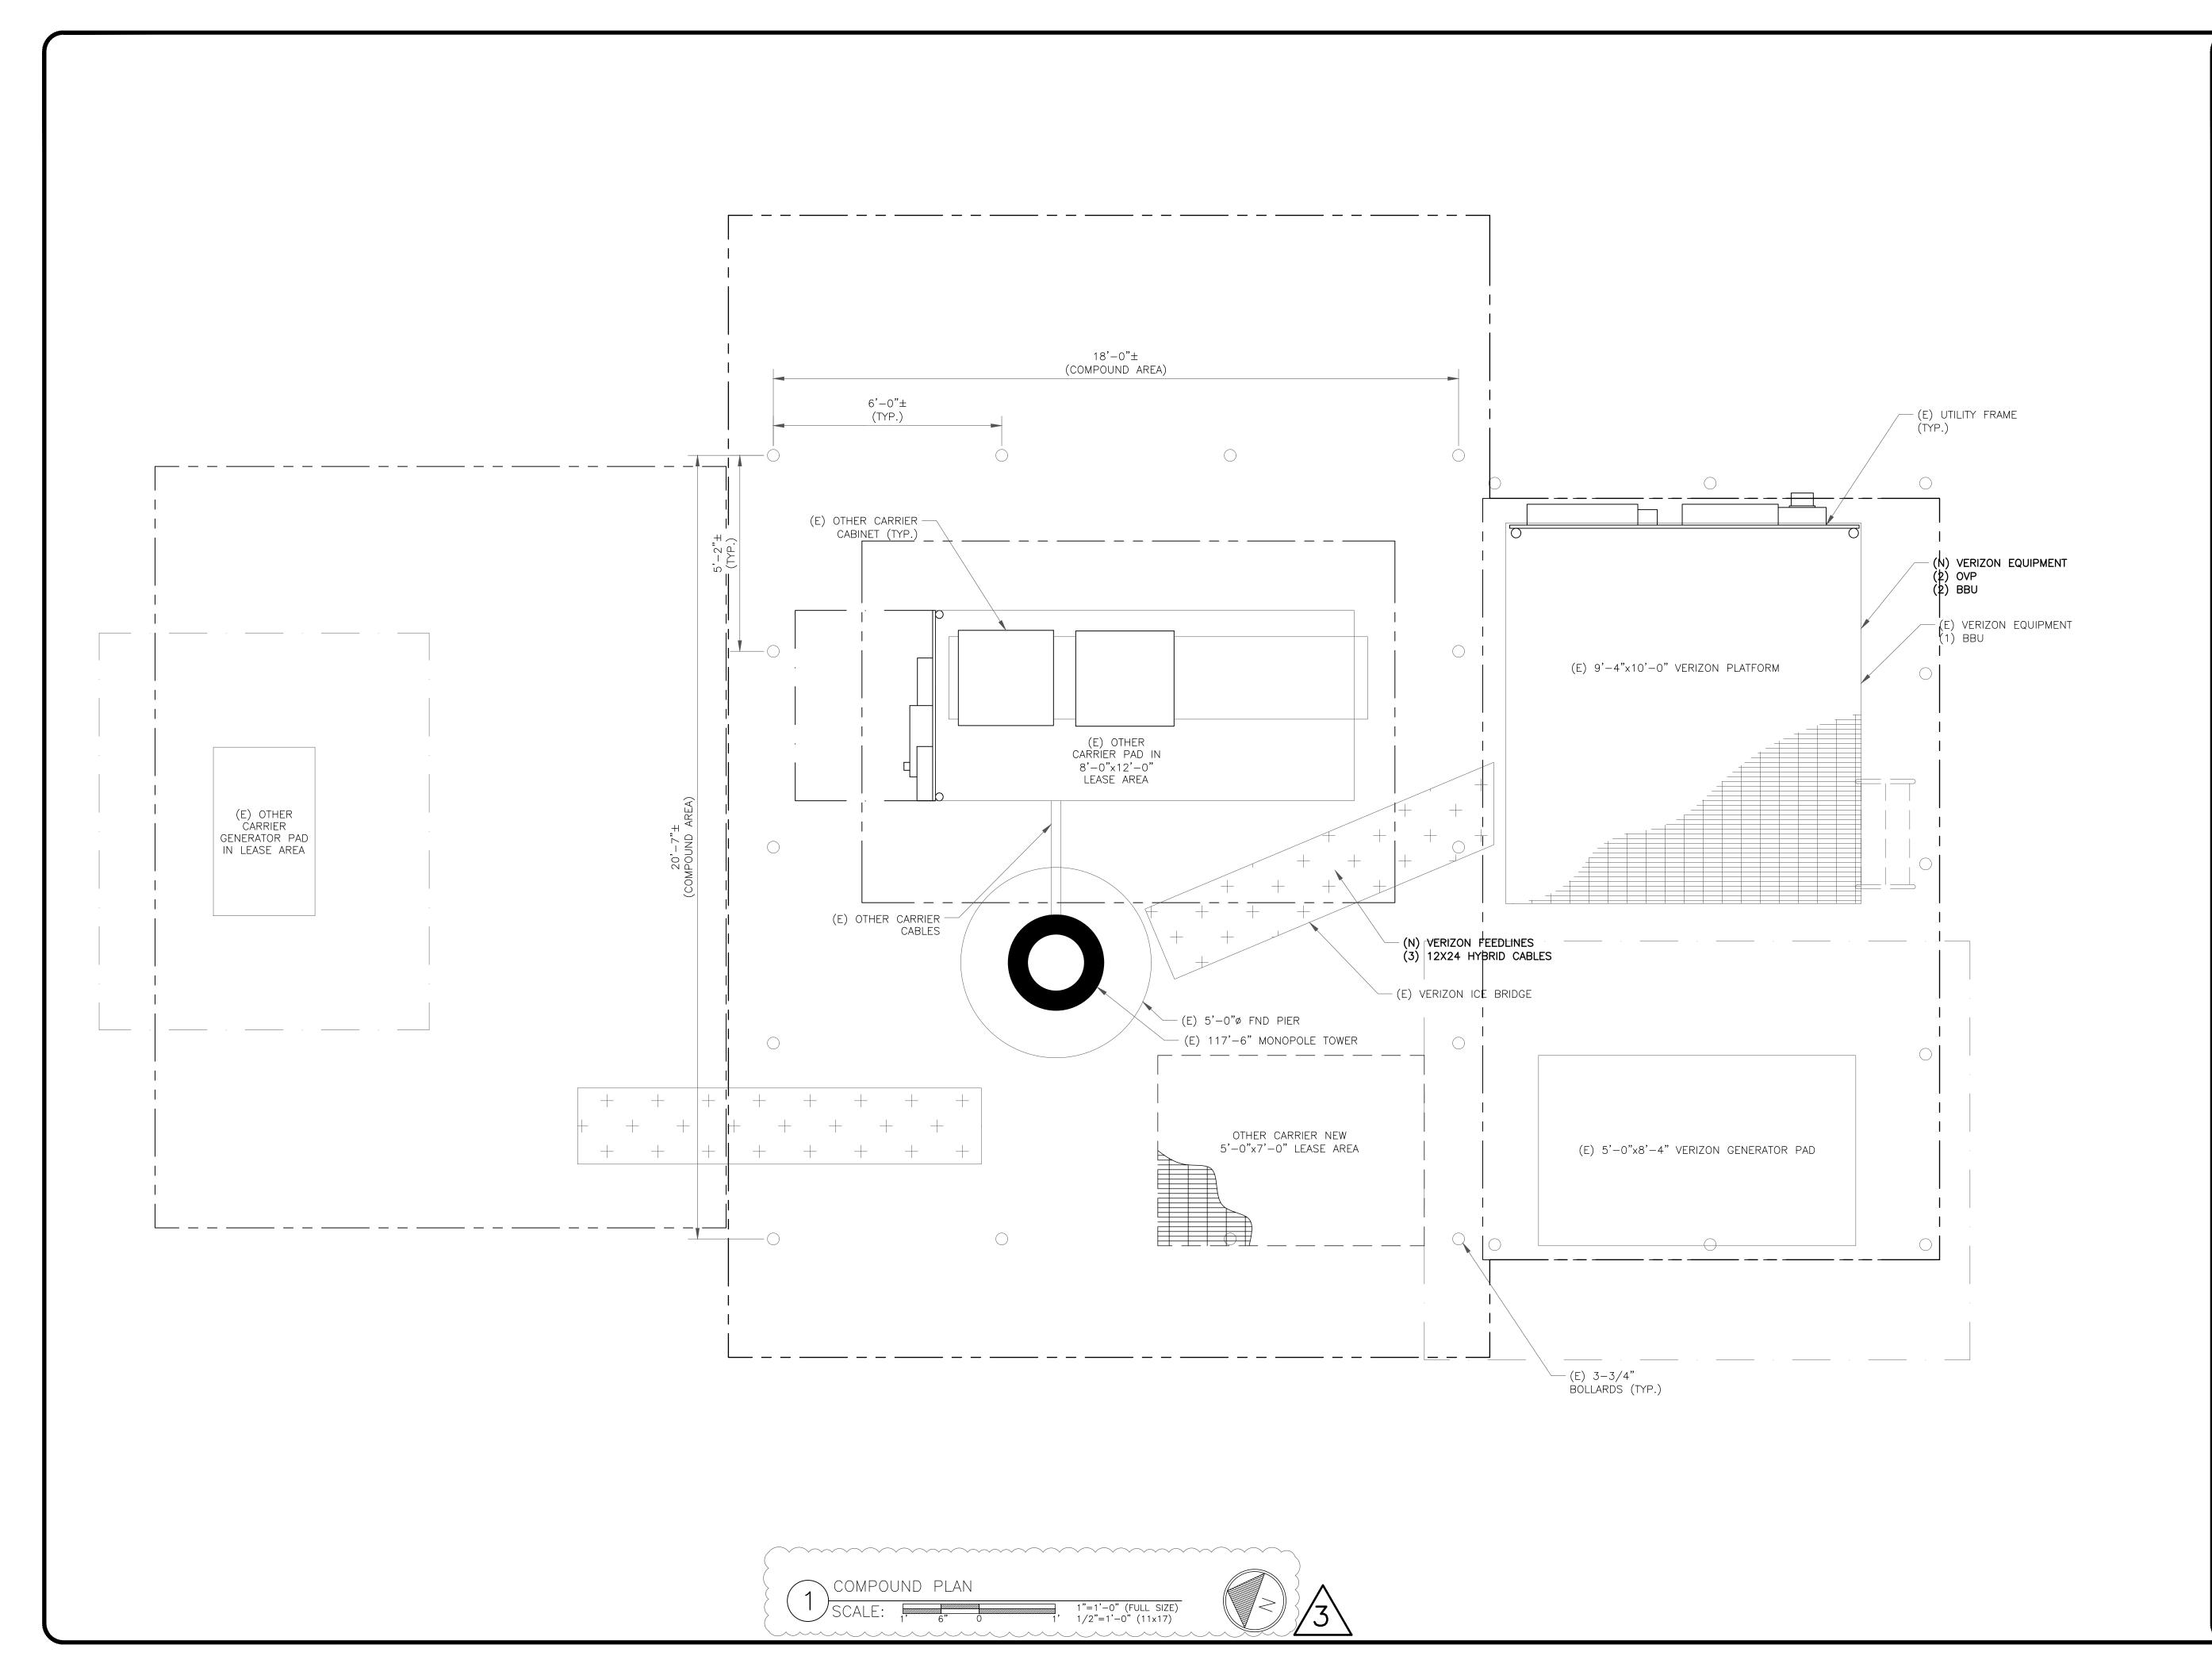
EXISTING 117'-6" MONOPOLE TOWER

\bigcap	ISSUED FOR:							
REV	REV DATE DRWN		DESCRIPTION	DES./QA				
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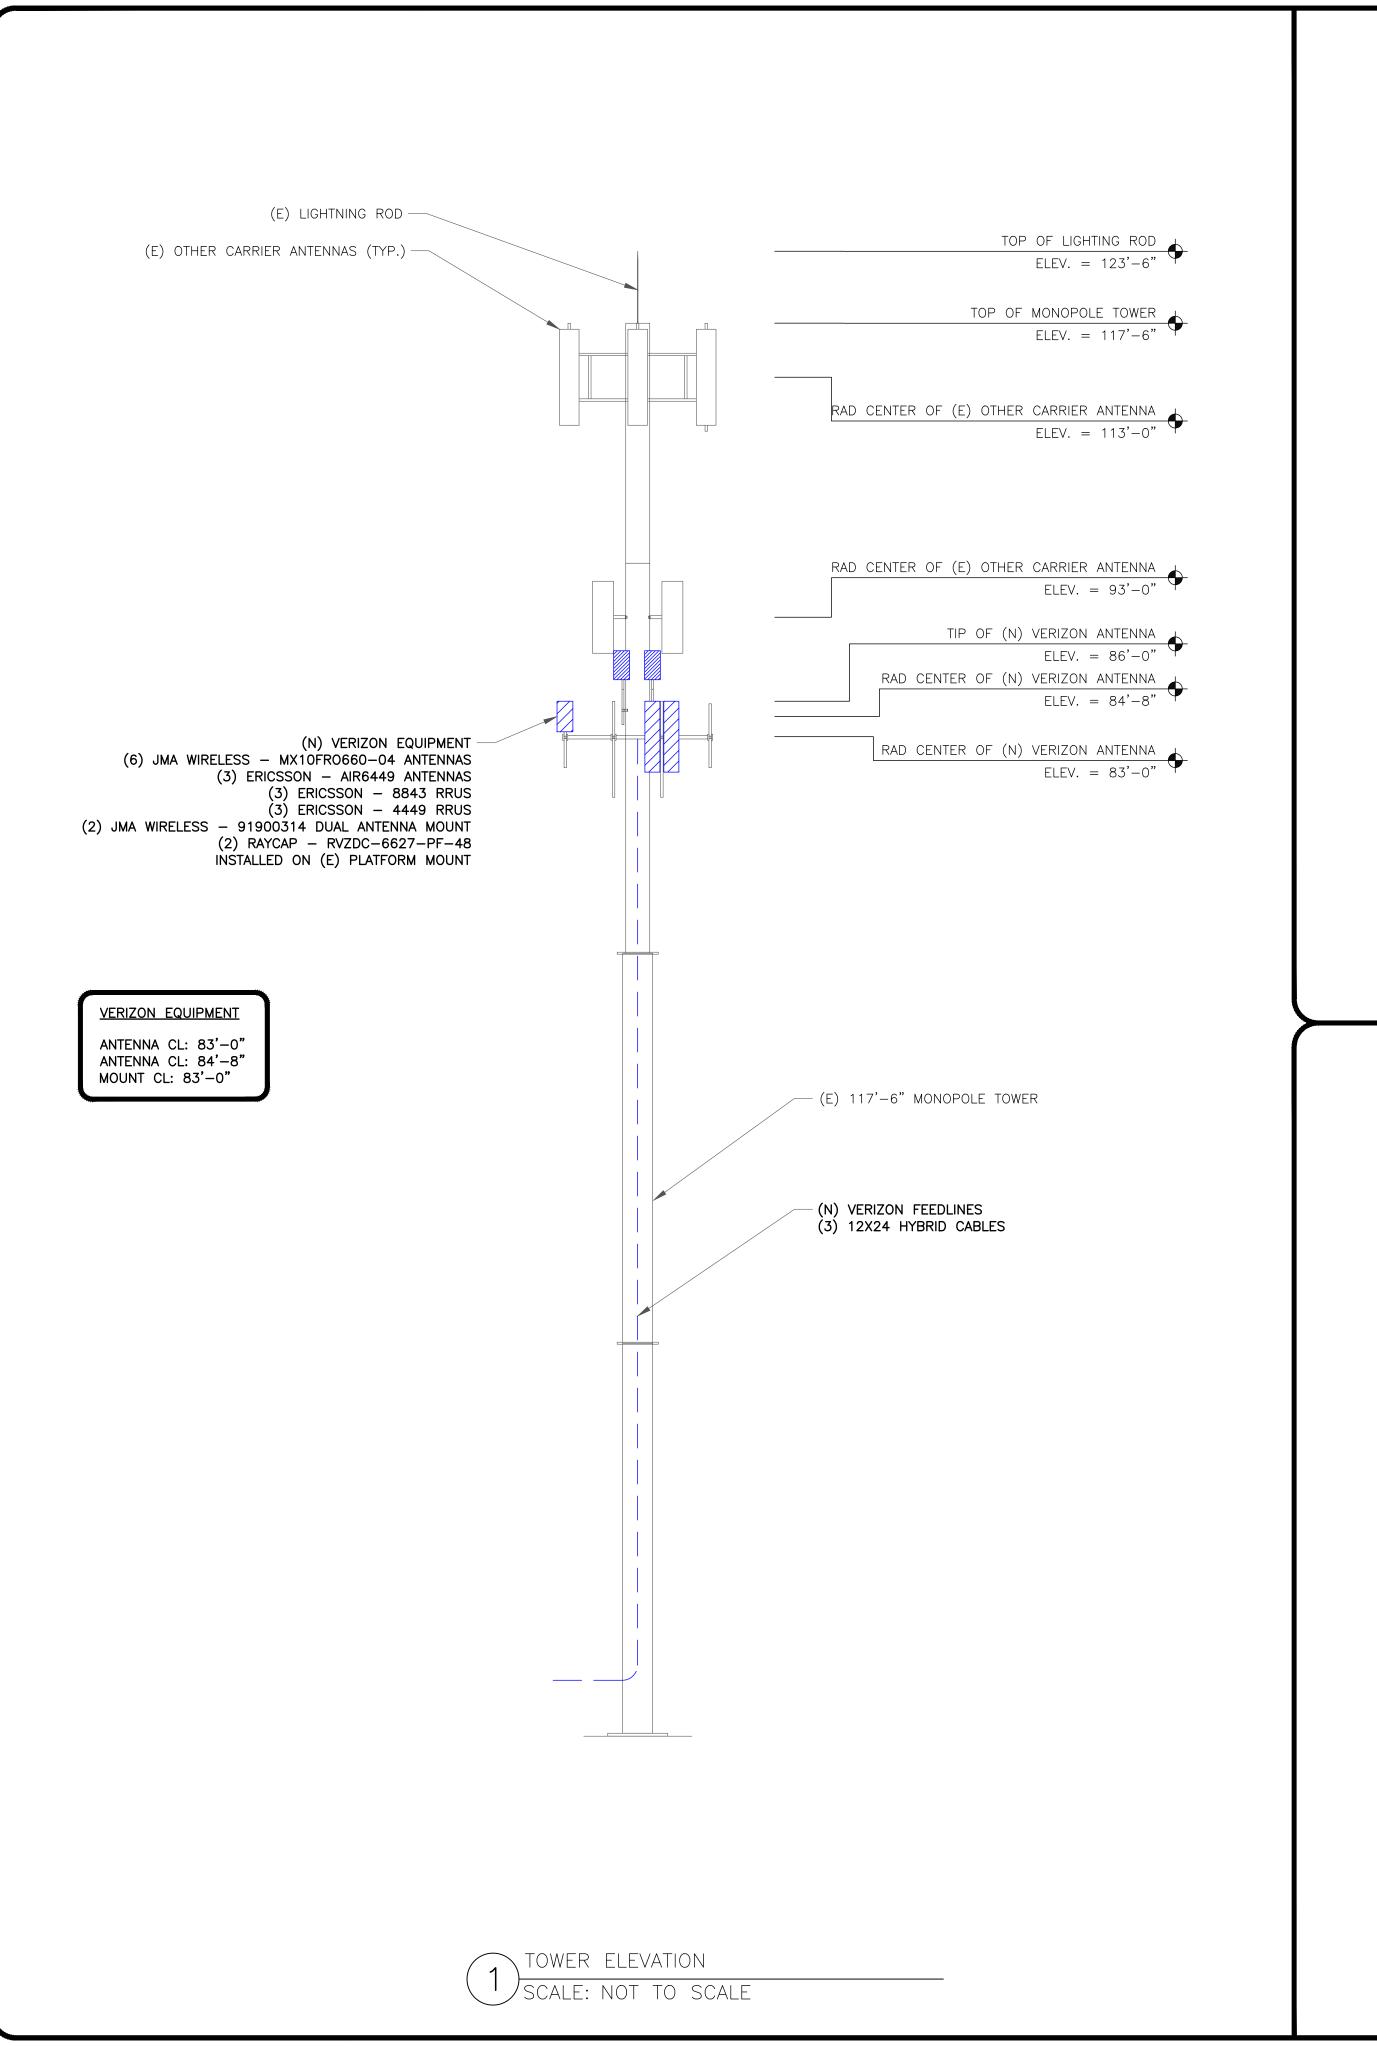
EXISTING 117'-6" MONOPOLE TOWER

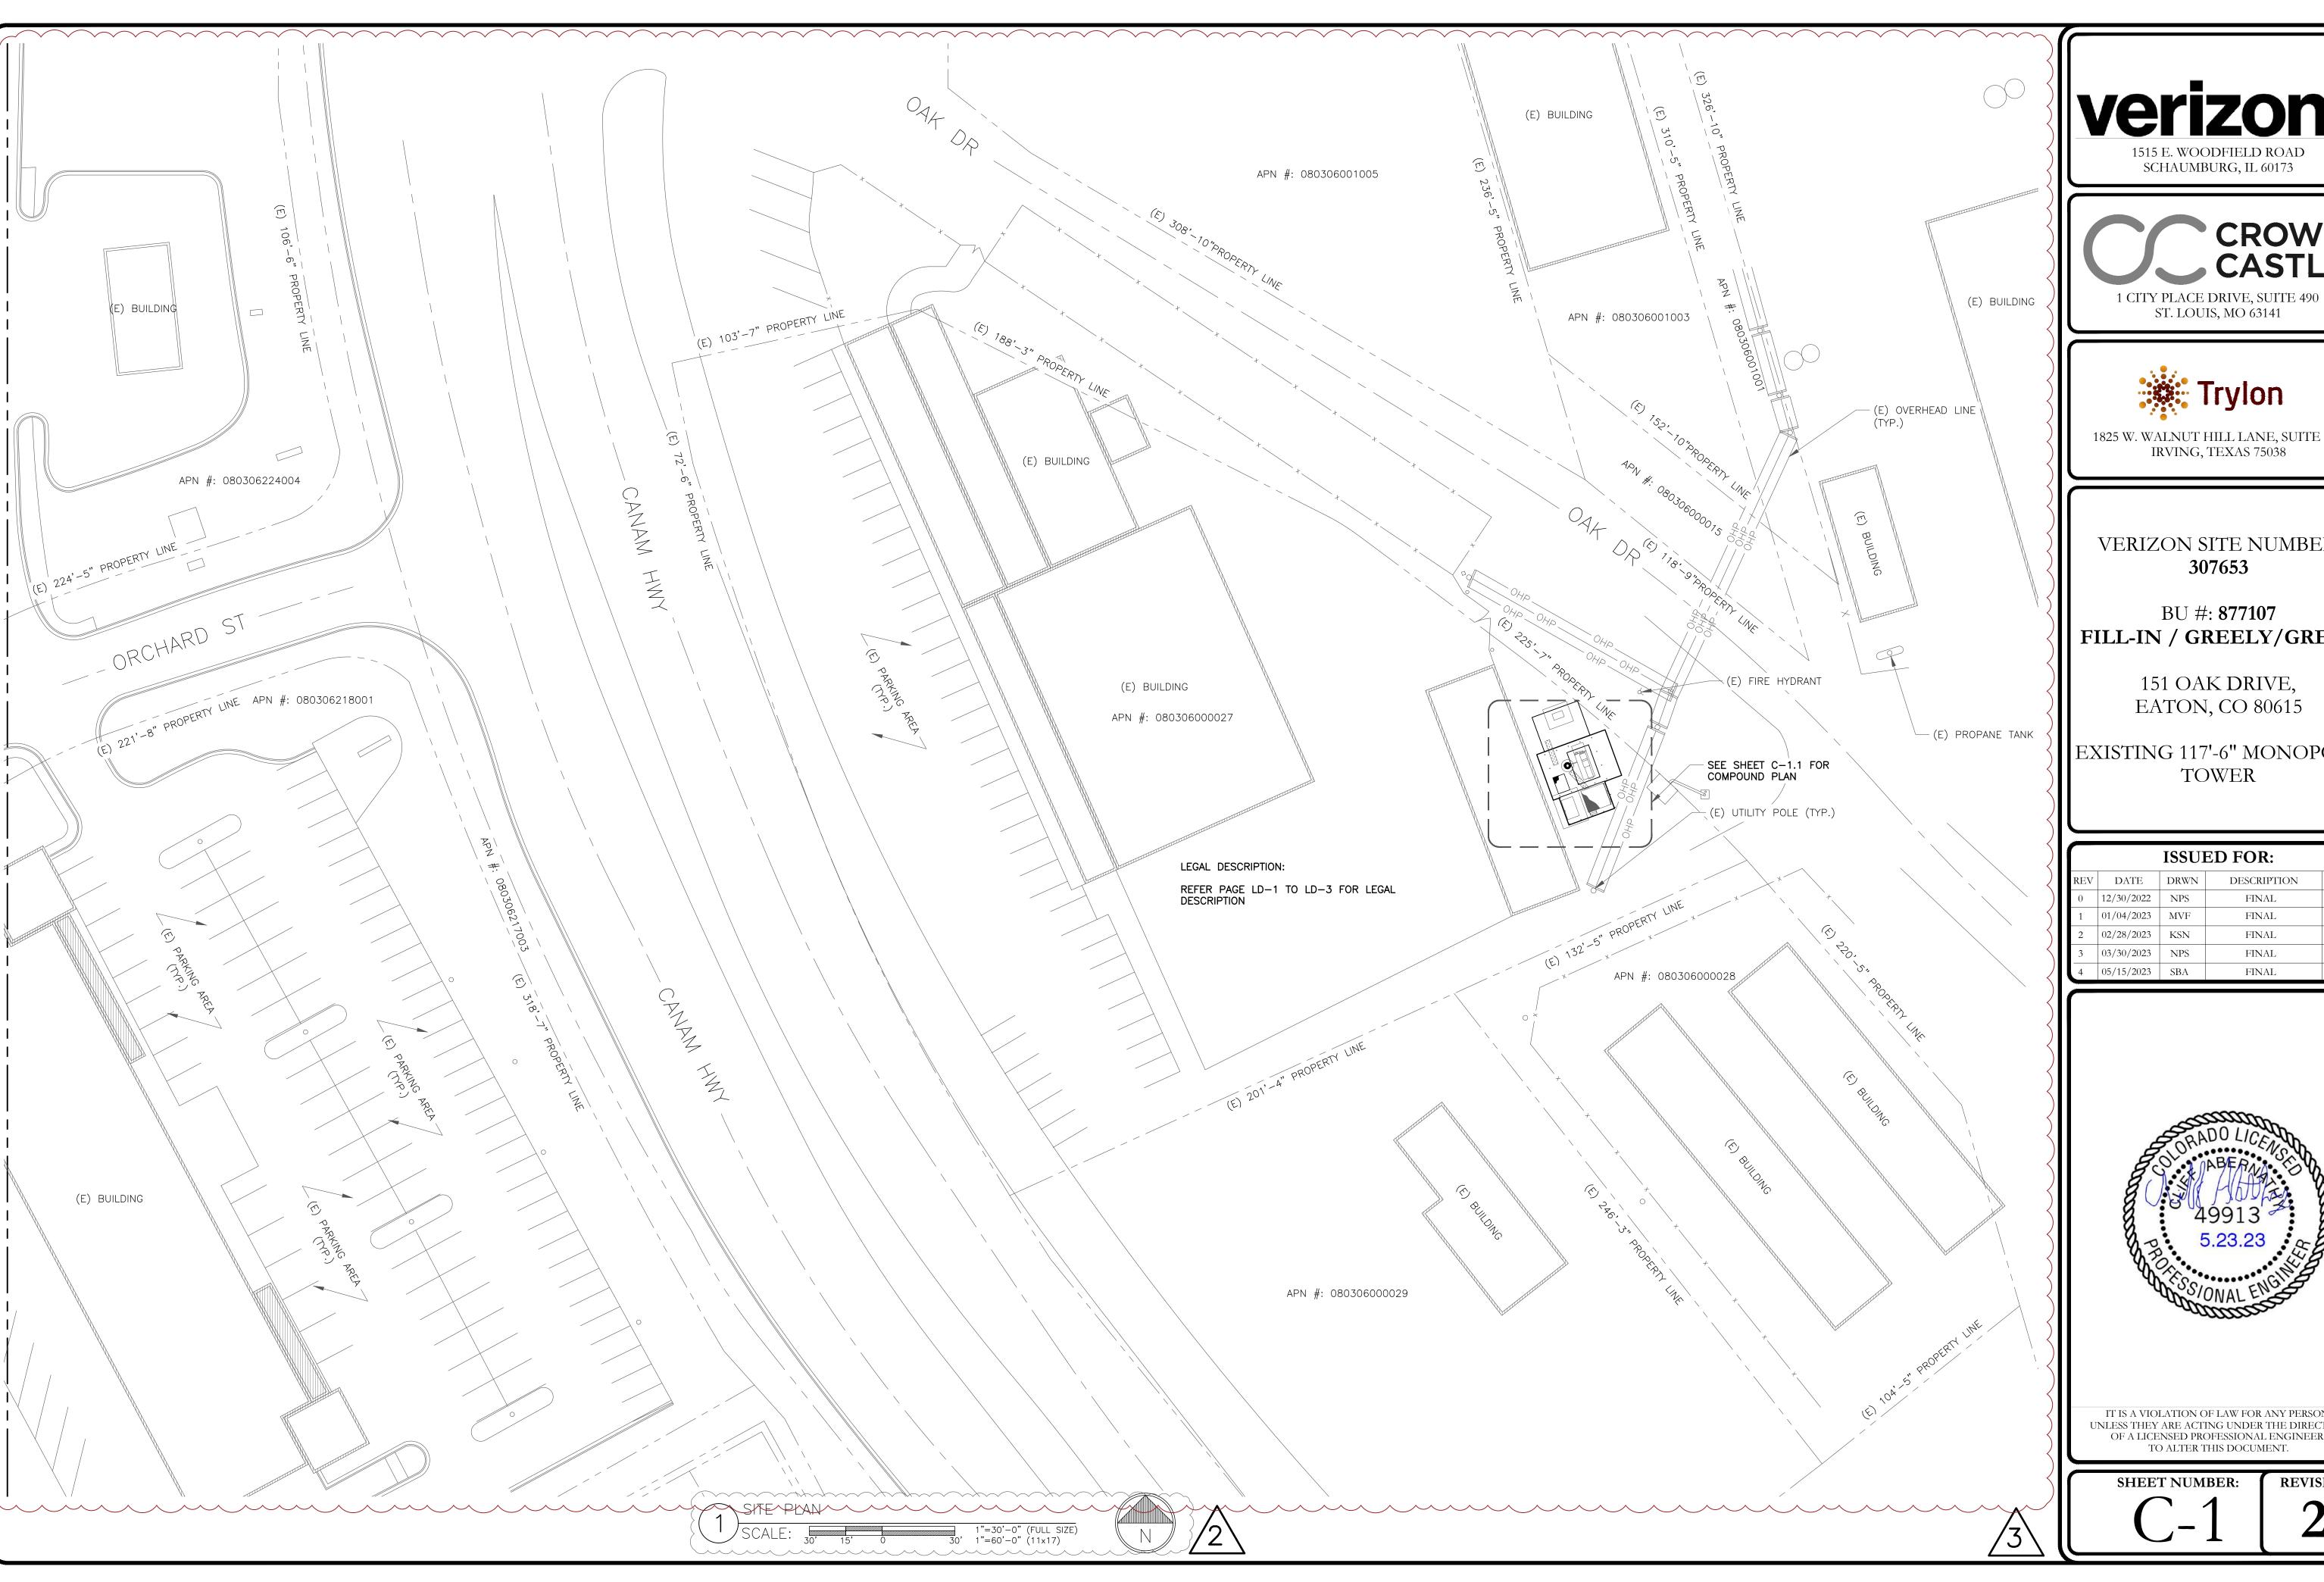
	ISSUED FOR:							
REV	DATE	DRWN	DESCRIPTION	DES./QA				
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3	03/30/2023	NPS	FINAL	AMT				
4	05/15/2023	SBA	FINAL	AMT				




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SHEET NUMBER:





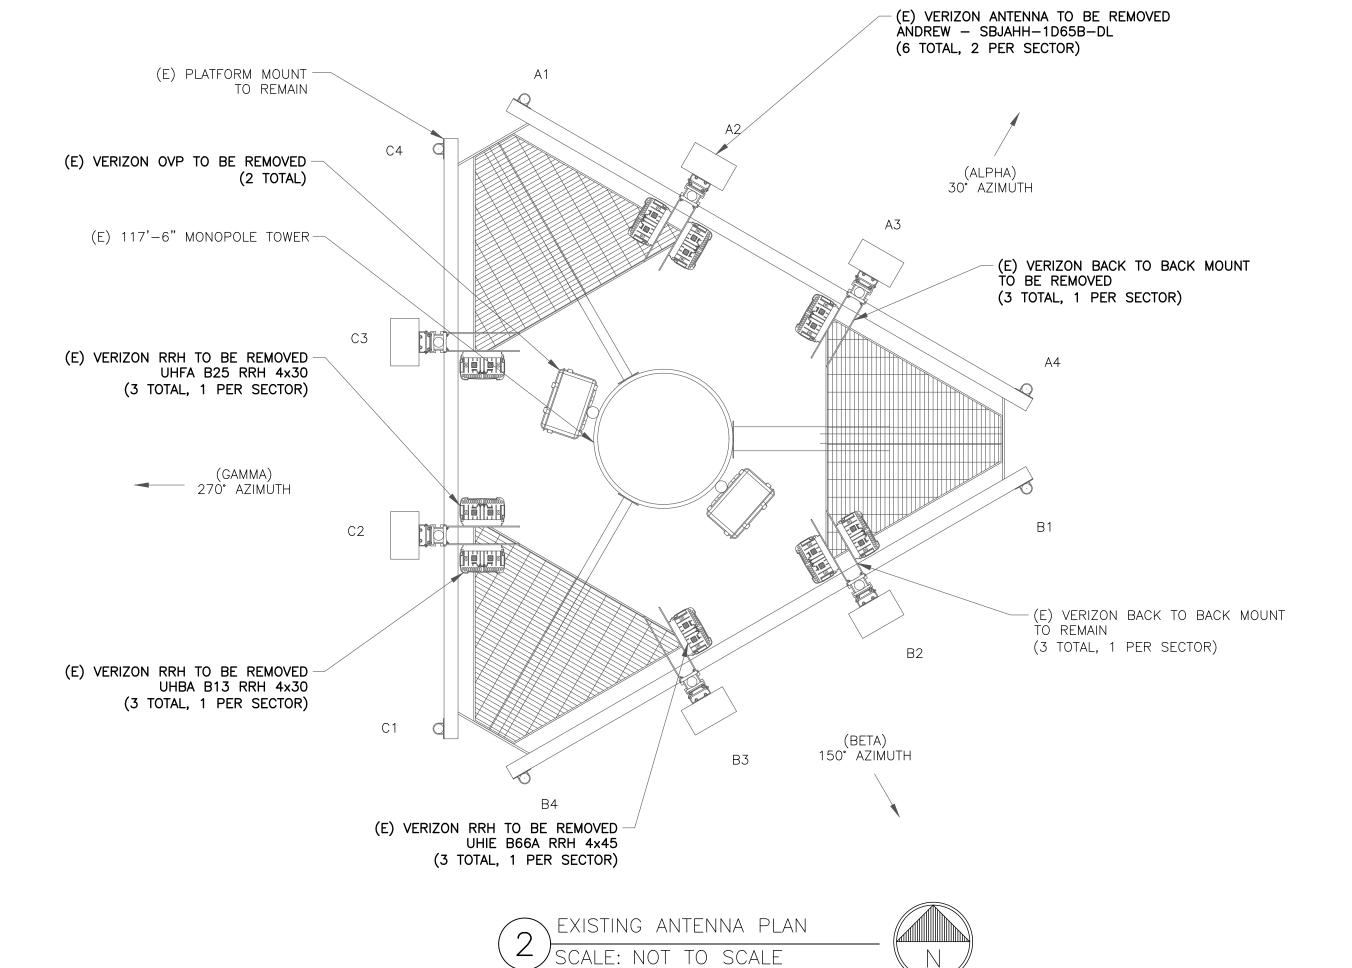

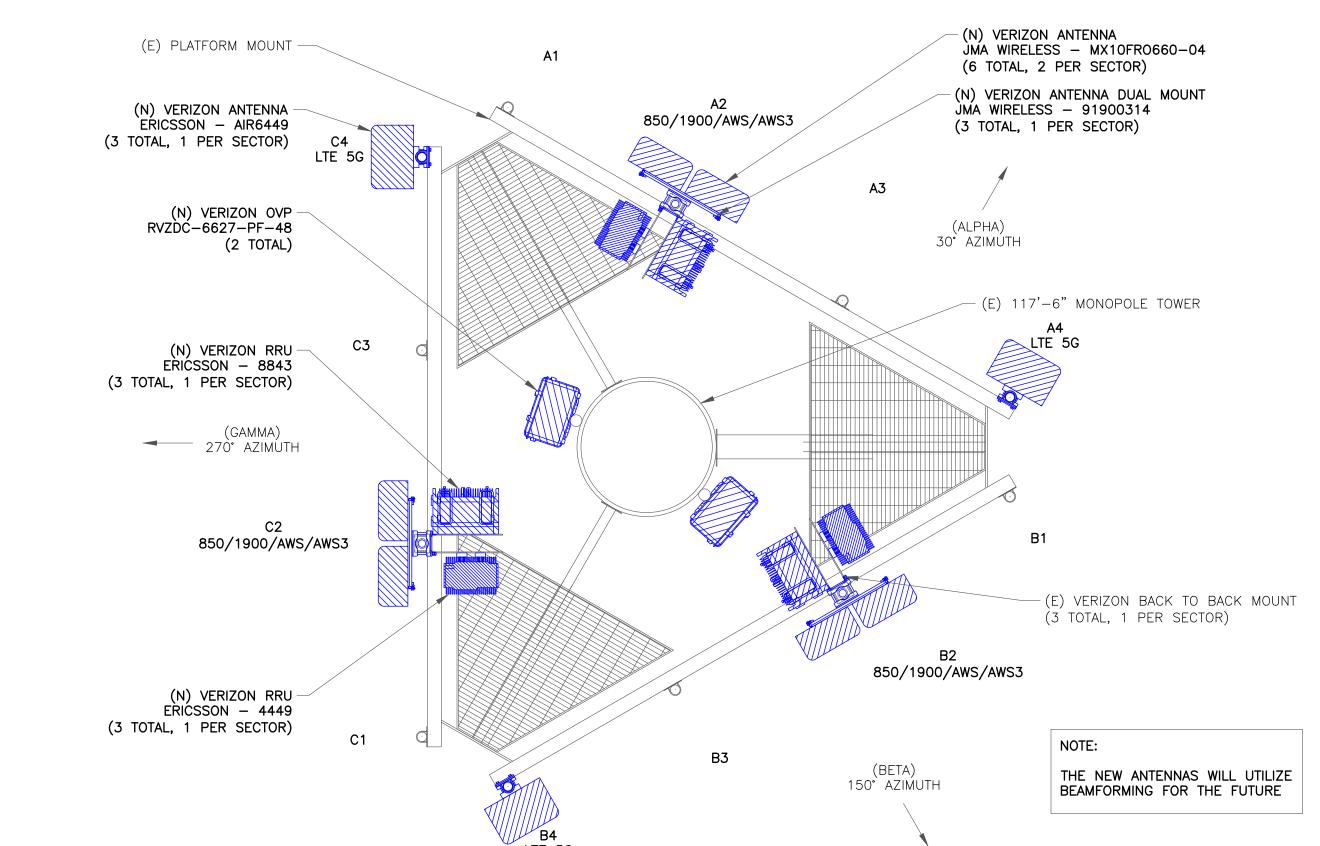NEW ANTENNA PLAN

CALE: NOT TO SCALE







1825 W. WALNUT HILL LANE, SUITE 120 IRVING, TEXAS 75038

VERIZON SITE NUMBER: 307653

BU #: **877107 FILL-IN / GREELY/GRE216**

> 151 OAK DRIVE, EATON, CO 80615

EXISTING 117'-6" MONOPOLE TOWER

	ISSUED FOR:							
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4	05/15/2023	SBA	FINAL	АМТ				




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SHEET NUMBER:

	ANTENNA/RRH SCHEDULE								
SECTOR	STATUS	ANTENNA MANUFACTURER	ANTENNA MODEL	ANTENNA CENTERLINE	AZIMUTH	MECHANICAL DOWNTILTS	ELECTRICAL DOWNTILTS	TOWER EQUIPMENT MANUFACTURER	TOWER EQUIPMENT QTY/MODEL
A1	-	_	-	-	-	-	-	_	
A2	NEW	JMA WIRELESS	(2) MX10FRO660-04	83'-0"	30°	0.	2*/0*/0*	ERICSSON ERICSSON	(1) RRUs 4449 (1) RRUs 8843
A3	-	_	_	-	_	_	_	_	_
A4	NEW	ERICSSON	(1) AIR 6449 B77	84'-8"	30°	0°	2*/0*/0*	_	-
B1	_	_	-	-	-	_	-	_	
B2	NEW	JMA WIRELESS	(2) MX10FR0660-04	83'-0"	150°	0•	2*/0*/0*	ERICSSON ERICSSON	(1) RRUs 4449 (1) RRUs 8843
В3	_	_	-	-	-	_	-	_	_
B4	NEW	ERICSSON	(1) AIR 6449 B77	84'-8"	150°	0*	2*/0*/0*	RAYCAP	(1) RVZDC-6627-PF-48
C1	_	-	-	-	-	_	-	_	_
C2	NEW	JMA WIRELESS	(2) MX10FR0660-04	83'-0"	270°	0*	2*/0*/0*	ERICSSON ERICSSON	(1) RRUs 4449 (1) RRUs 8843
C3	_	_	_	-	-	_	-	_	_
C4	NEW	ERICSSON	(1) AIR 6449 B77	84'-8"	270°	0°	2*/0*/0*	RAYCAP	(1) RVZDC-6627-PF-48

CABLE SCHEDULE							
STATUS CABLE TYPE SIZE LENGTH QTY							
NEW	HYBRID	12x24	100'-0"±	3			
TOTAL CABLE QTY:	TOTAL CABLE QTY:						



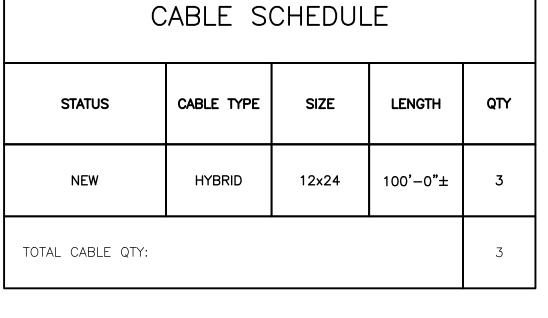





1825 W. WALNUT HILL LANE, SUITE 120 IRVING, TEXAS 75038

VERIZON SITE NUMBER: 307653

BU #: **877107** | FILL-IN / GREELY/GRE216 |

> 151 OAK DRIVE, EATON, CO 80615

EXISTING 117'-6" MONOPOLE TOWER

	ISSUED FOR:							
REV	DATE	DRWN	DESCRIPTION	DES./QA				
0	12/30/2022	NPS	FINAL	AMT				
1	01/04/2023	MVF	FINAL	AMT				
2	02/28/2023	KSN	FINAL	AMT				
3	03/30/2023	NPS	FINAL	AMT				
4	05/15/2023	SBA	FINAL	AMT				




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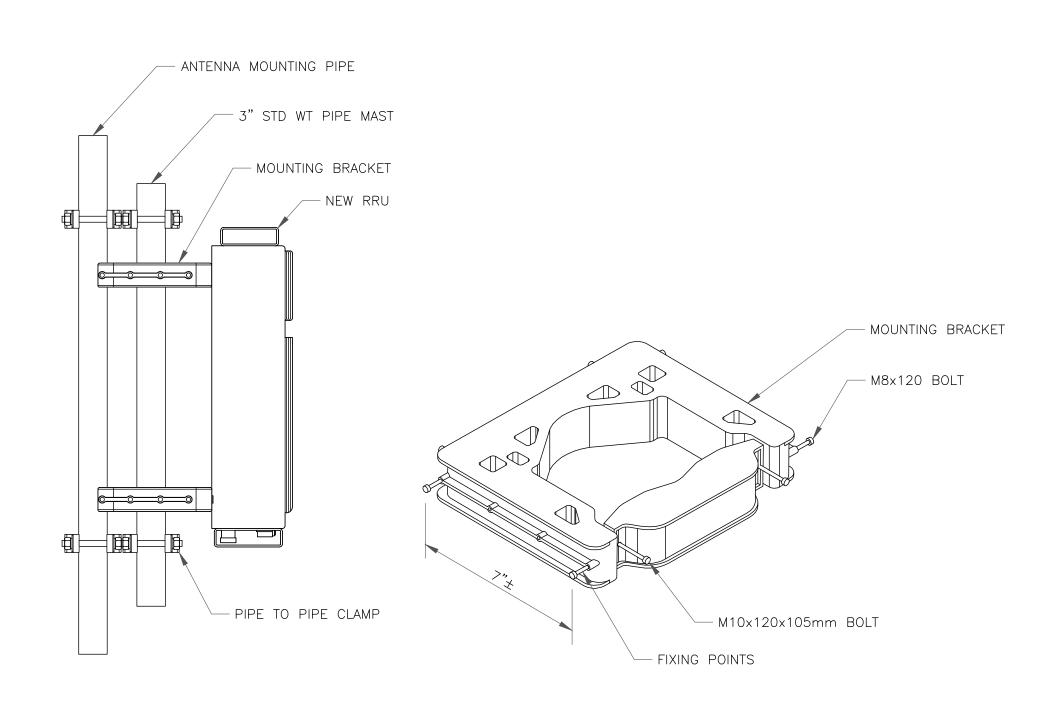
SHEET NUMBER:

REVISION:

VERIZON TOWER EQUIPMENT SCHEDULE SCALE: NOT TO SCALE

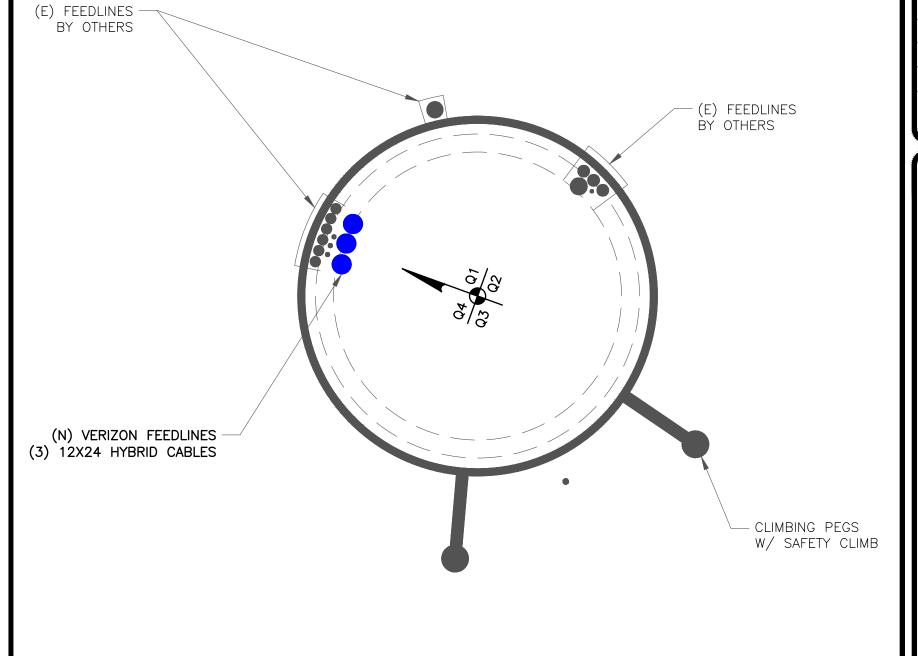

BASE LEVEL DETAIL
SCALE: NOT TO SCALE



NOKIA - FPKA BRACKET MOUNTING DETAIL

SCALE: NOT TO SCALE

NOT USED

SCALE: NOT TO SCALE







IRVING, TEXAS 75038

VERIZON SITE NUMBER: 307653

BU #: **877107 FILL-IN / GREELY/GRE216**

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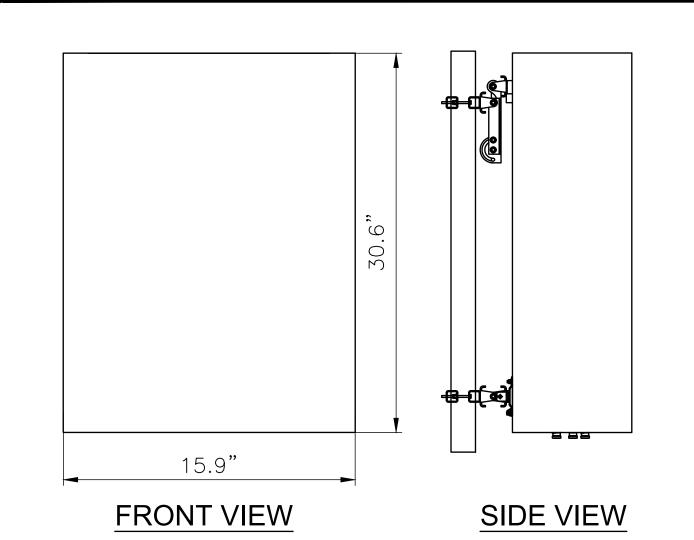



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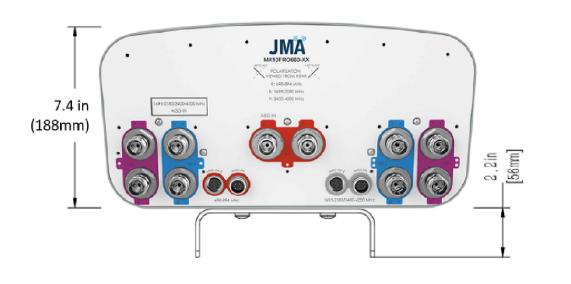
DIMENSIONS (HxWxD)

WEIGHT W/O MOUNTING KIT 95.50 LBS.

30.60"x15.90"x10.60"

1 ERICSSON - AIR6449 DETAIL SCALE: NOT TO SCALE

BOTTOM VIEW

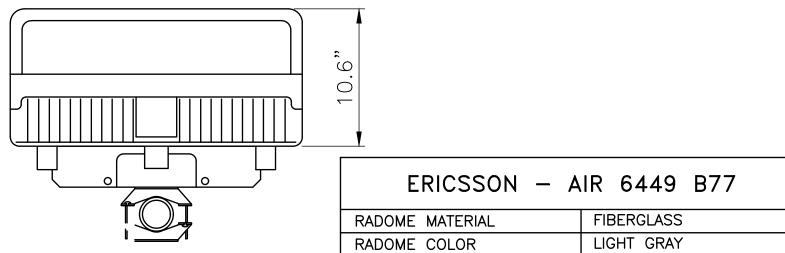



Mechanical specifications		
Dimensions height/width/depth, inches (mm)	70.9/ 15.0/ 7.4 (1800/ 381.0/ 188.0)	
Shipping dimensions length/width/height, inches (mm)	76/ 20/ 14.5 (1930/ 508/ 368)	
No. of RF input ports, connector type, and location	10 x 4.3-10 female, bottom	
RF connector torque	96 lbf-in (10.85 N·m or 8 lbf-ft)	
Net antenna weight, lb (kg)	57.3 (26)	
Shipping weight, ib (kg)	100.7 (45.7)	
Antenna mounting and downtilt kit included with antenna	91900318	
Net weight of the mounting and downtlit kit, lb (kg)	20.3 (9.2)	
Range of mechanical up/down tilt	-2° to 12°	
Rated wind survival speed, mph (km/h)	150 (241)	
Frontal and lateral wind loading @ 150 km/h, lbf (N)	157.3 (699.7), 56.9 (253.1)	
Equivalent flat plate @ 100 mph and Cd=2, sq ft	1.71	
EPA frontal and lateral, ft ² , (m ²)	7.1 (0.66), 3.6 (0.33)	

Electrical specification (minimum/maximum)		Ports 7, 8, 9, 10				
Frequency bands, MHz	3400-3550	3550-3700	3700-3950	3950-4200		
Polarization		± 45°				
Average gain over all tilts, dBi	13.6	13.8	14.0	14.2		
Horizontal beamwidth (HBW), degrees	64	62	60	58		
Front-to-back ratio, co-polar power @180°± 30°, dB	>23	>23	>23	>22		
Vertical beamwidth (VBW), degrees ¹	20	19.6	19.3	18.5		
Electrical downtilt (EDT) range, degrees	2	2-12 orderable in	1 deg increment	S		
First upper side lobe (USLS) suppression, dB ¹	≤-15	≤-15	≤-15	≤-15		
Cross-polar isolation, port-to-port, dB ¹	25	25	25	25		
Max VSWR / return loss, dB		1.5:1	/-14.0			
Max input power per any port, watts		150				
Total composite power all ports (1-10), watts		15	500			

JMA WIRELESS - MX10FR0660-04 DETAIL

SCALE: NOT TO SCALE

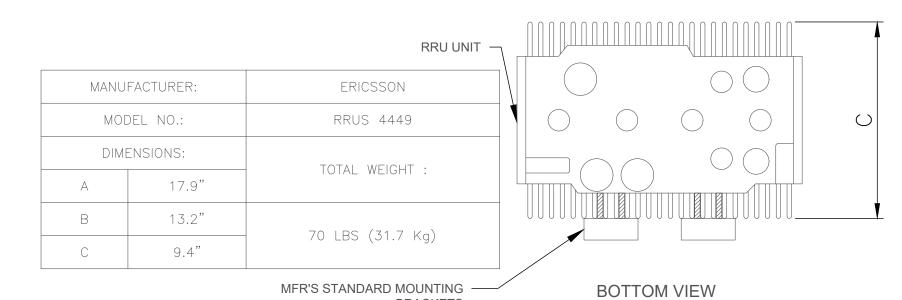

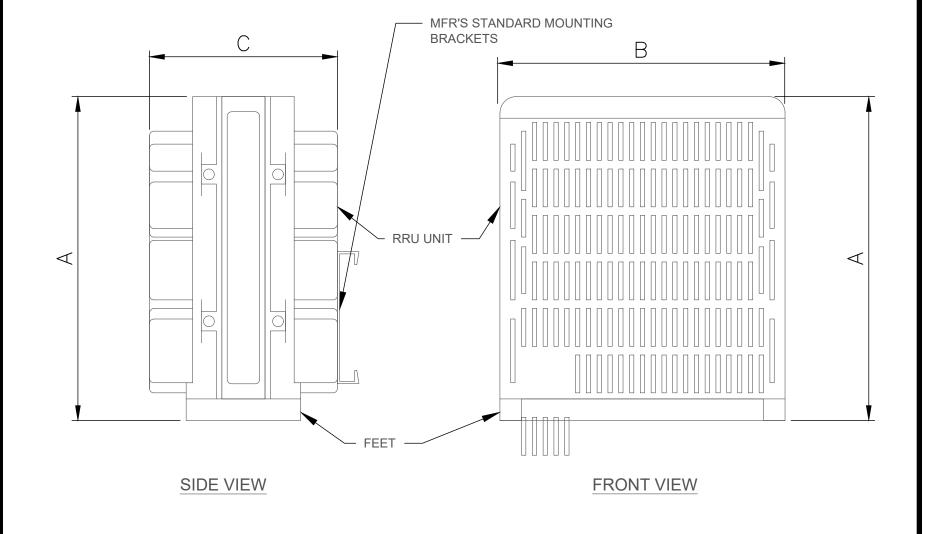

SCALE: NOT TO SCALE







1825 W. WALNUT HILL LANE, SUITE 120 IRVING, TEXAS 75038

VERIZON SITE NUMBER: 307653

BU #: **877107 FILL-IN / GREELY/GRE216**

> 151 OAK DRIVE, EATON, CO 80615

EXISTING 117'-6" MONOPOLE TOWER


	ISSUED FOR:					
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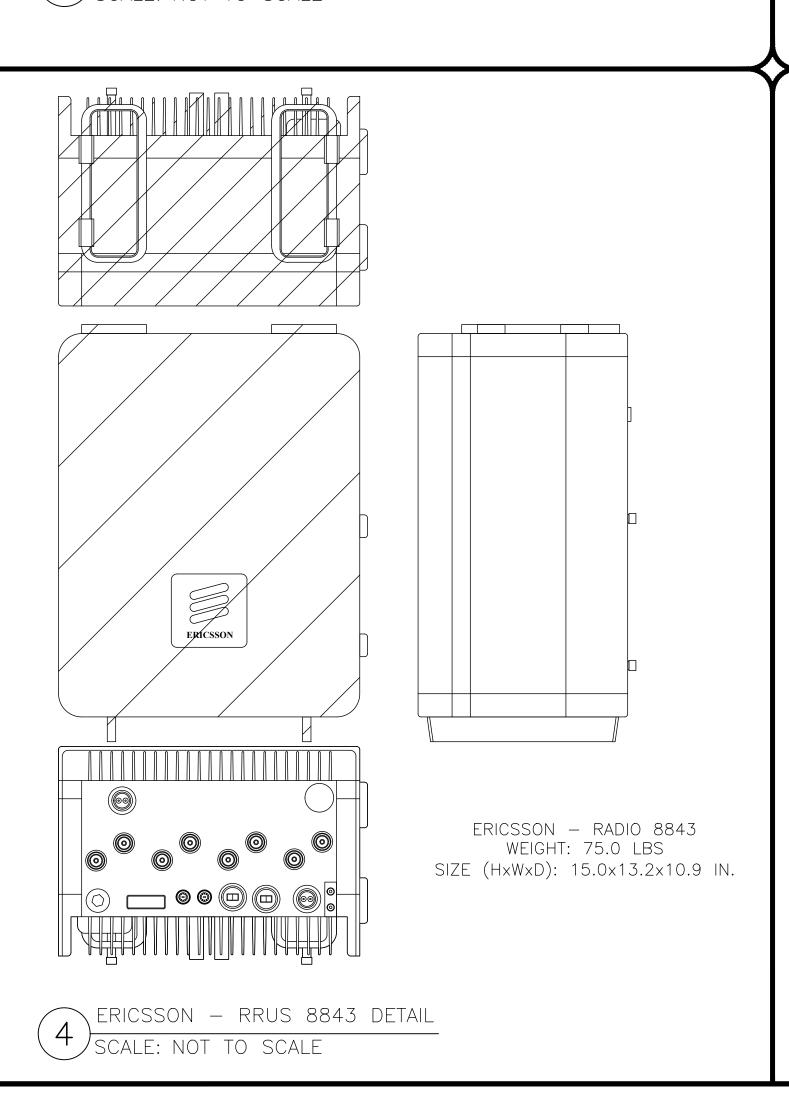



RAYCAP — RVZDC-6627-PF-48
WEIGHT (WITHOUT MOUNTING HARDWARE): 32.0 LBS
SIZE (HxWxD): 29.5x16.5x12.6 IN.

RATED WIND VELOCITY: 150 MPH (SUSTAINED)
OPERATING TEMPERATURE: -40° C TO +80° C
NOMINAL OPERATING DC VOLTAGE: 48 VDC
VOLTAGE PROTECTION RATING (VRP): 400V

8 RVZDC-6627-PF-48 - RAYCAP DETAIL
SCALE: NOT TO SCALE


RVZDC-4520-RM-48 - RAYCAP DETAIL
SCALE: NOT TO SCALE

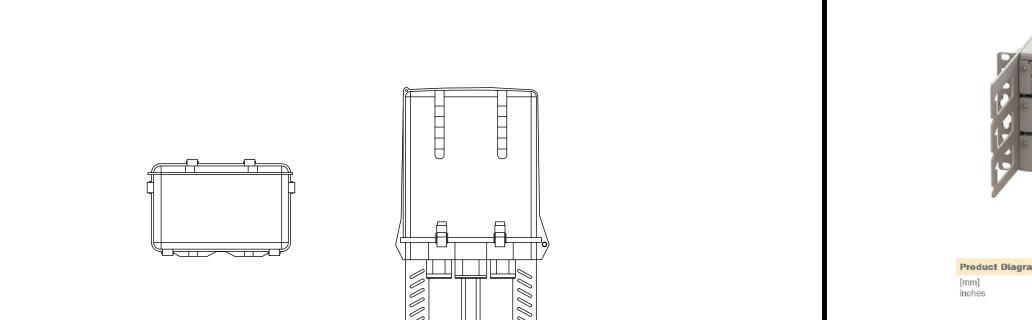

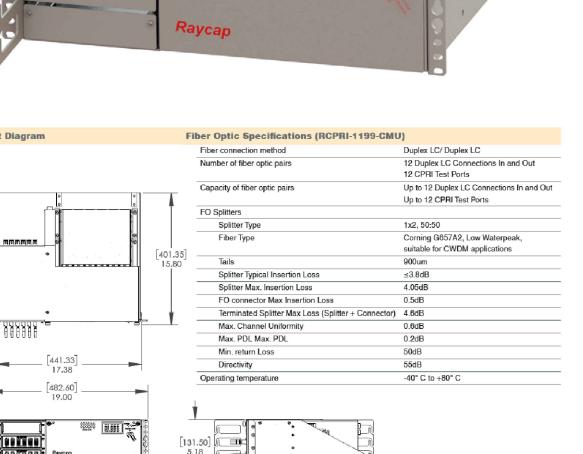

Product Specifications



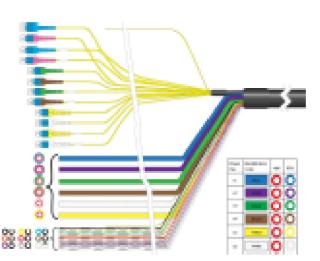

HFT1206-24SVL-190

HELIAX® FiberFeed® Hybrid Cable Assembly, 6X12, Low Inductance, UL Type RHC, 12 power conductors 6 AWG, 24-fiber, 18 alarm wires, PVC jacket, aluminum armor, 190 ft

Construction Materials

Fiber Type Bend insensitive singlemode fiber (G.657.A2)

Total Fibers, quantity 2

Armor Type Corrugated aluminum

Jacket Color Black

Dimensions

Cord Length	57.91 m 190.00 ft
Breakout Length, Fiber, end 1	900 mm 35 in 950 mm 37 in 1000 mm 39 in
Breakout Length, Power, end 1	312 mm 12 in 388 mm 15 in 490 mm 19 in
Breakout Length, Fiber, end 2	900 mm 35 in 950 mm 37 in 1000 mm 39 in
Breakout Length, Power, end 2	725 mm 29 in

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All specifications are subject to change without notice. See www.commscope.com for the most current information. Revised: January 16, 2016

Environmental Specifications

Environmental Space Wireless installation

Operating Temperature -40 °C to +80 °C (-40 °F to +176 °F)

General Specifications

Conductors, quantity 1

Construction Type Hybrid standard trunk

Alarm Wire Gauge 18 AWG

Alarm Wire, quantity 18

Center Conductor Gauge 6 AWG

Interface Body Style, connector A Straight

Interface Body Style, connector B Straight

Interface Feature, connector A Standard

Interface Feature, connector B Standard

Interface, connector A DLC

Interface, connector B DLC

Minimum Bend Radius, furcation 30.0 mm | 1.2 in

The state of the s

Product Specifications

COMMSCSPE*

HFT1206-24SVL-190

Regulatory Compliance/Certifications

Agency Classification RoHS 2011/65/EU Compliant

ISO 9001:2008 Designed, manufactured and/or distributed under this quality management system



Included Products

760210922 | HRC-24SM-1206C-1818-APV (Product Component—not orderable) — HELIAX® FiberFeed® Hybrid Cable with Concentric Conductors, UL Type RHC

CS-8G-MP (Product Component—not orderable) — Enhanced Low Macrobending, Zero Water Peak,
 Dispersion-Unshifted Singlemode Fiber (ITU-T G.657.A2, B2)







IRVING, TEXAS 75038

VERIZON SITE NUMBER:

307653

BU #: **877107 FILL-IN / GREELY/GRE216**

> 151 OAK DRIVE, EATON, CO 80615

EXISTING 117'-6" MONOPOLE TOWER

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REV	DATE	DRWN	DESCRIPTION	DES./QA		
0	12/30/2022	NPS	FINAL	AMT		
1	01/04/2023	MVF	FINAL	AMT		
2	02/28/2023	KSN	FINAL	AMT		
3	03/30/2023	NPS	FINAL	AMT		
4	05/15/2023	SBA	FINAL	AMT		



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REVISION:

SHEET NUMBER:

page 2 of 2

February 14, 2016

HEET NUMBER:

COMMSCOPE HFT1206-24SVL-190 DETAIL
SCALE: NOT TO SCALE

page 1 of 2

February 14, 2016

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All specifications are subject to change without notice. See www.commscope.com for the most current information. Revised: January 16, 2016



Specification

item	value
Place of Origin	China
	Shandong
Brand Name	ERICSSON
Model Number	Baseband 6648 KDU 137 0015/11
Condition	Un Used
External dimension	58CM*46CM*9 CM
Internal dimension	48.5CM*39CM*4.5CM
Gross weight	8.7KG
Net weight	8KG

BBU 6648 DETAIL SCALE: NOT TO SCALE N/A

BBU NTB1010067/13 DETAIL
SCALE: NOT TO SCALE

NOT USED

SCALE: NOT TO SCALE

verizon SCHAUMBURG, IL 60173





1825 W. WALNUT HILL LANE, SUITE 120 IRVING, TEXAS 75038

VERIZON SITE NUMBER: 307653

BU #: **877107** | FILL-IN / GREELY/GRE216 |

> 151 OAK DRIVE, EATON, CO 80615

EXISTING 117'-6" MONOPOLE TOWER

ISSUED FOR:					
REV	DATE	DRWN	DESCRIPTION	DES./QA	
0	12/30/2022	NPS	FINAL	AMT	
1	01/04/2023	MVF	FINAL	AMT	
2	02/28/2023	KSN	FINAL	AMT	
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4	05/15/2023	SBA	FINAL	AMT	



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SHEET NUMBER:

REVISION:

5 NOT USED
SCALE: NOT TO SCALE

Dual-mount antenna bracket

- Enables optimal spacing for low-band 4T4R beamforming by allowing for two of the same antenna on one bracket
- Mechanical tilt in line with specified antenna
- Spacing achieved can be 3/4", 2", or 12" (edge-to-edge) dependent on antenna model
- Compatible with MX*, MC*, X7C*, C7C* antenna ranges


Spacing options between dual antennas					
X7C* and C7C*	2 of same antennas locked at 2" spacing				
models	Example: (2) X7CQAP-FRO-645-V can be locked at 2" of spacing				
	2 of same antennas locked at 3/4", 2", or 12" spacing				
MX*, MC* models	Example: (2) MX08FRO660-02 can be locked at 2" or 12" spacing (see above image)				

Brackets needed per antenna type All 4' and these 6' antennas: X7CAP-665-V X7CQAP-FRO-645-V X7C-665-V X7CQAP-FRO-660-V X7C-FRO-640-V X7C-680-V 91900314-02 X7C* and X7CQAP-665-V X7C-FRO-660-V C7C-FRO-656-V (2 brackets needed) C7C* C7CQCAP-FRO-656-V models All 8' and this 6' antenna: 91900314-03 X7CAP-FRO-640-V (3 brackets needed)

MX*, MC*	4', 6' antennas	91900314-02				
models	8' antennas	91900314-03				
Mechanica	Mechanical specifications					
Weight per bracket, lb (kg)		28 lb (12.7 kg) – dual mount bracket parts only				
Range of allowable mechanical up/down tilt		Tilt range is not affected by dual mount bracket (see antenna datasheet)				
Rated wind survival speed, mph (km/h)		150 mph (241 km/h)				
And the state of t		DAONA DOCUMENTAL DE LA CALLA DEL CALLA DE LA CALLA DEL CALLA DE LA				

Material specification	0.16" to 0.25" thick hot-dipped, galvanized steel				
Ordering information					
Mounting bracket model Description					
91900314-01	Single dual-mount antenna bracket assembly (see table above, "Brackets per antenna type")				
91900314-02	Two dual-mount antenna bracket assemblies				
91900314-03 Three dual-mount antenna bracket assemblies					
*Compatible antennas					
4'-8' Quad-, Hex-, and Octo-Port macro antennas in the X7C; C7C; X7CAP; C7CAP; X7CQAP; MX, MC models					
Installation instructions					
81900506	Installation instructions for dual-mount bracket assembly (comes with kit)				

Dual-mount bracket assembly guide overview

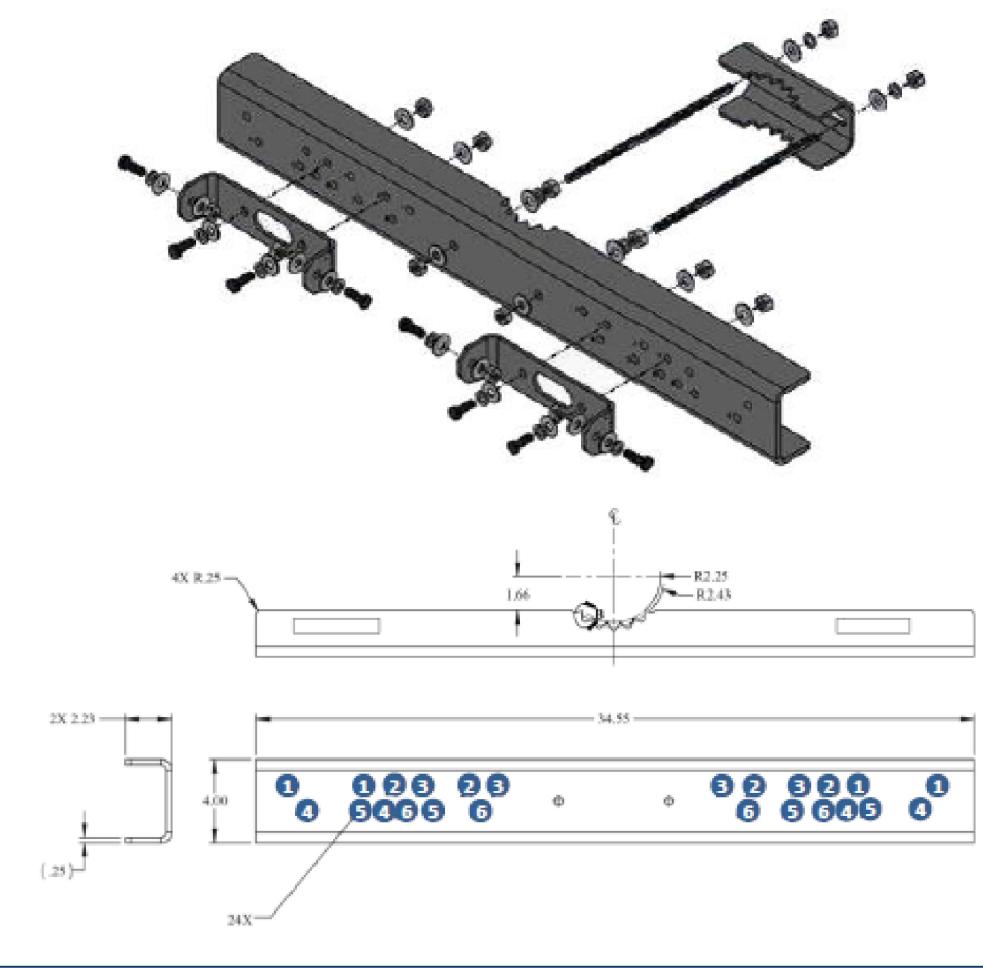

Model types beginning with:	Antenna width	Corresponding hole position	Resulting spacing between antennas
	15.4" (wide spacing)	1	12"
BANK BACK	15.4" (narrow spacing)	2	2"
MX*, MC*	12"	3	2"
	20"	5	3/4"
	12.5"	3	2"
want nant	24.0"	4	2"
X7C*, C7C*	18.8"	5	2"
	14.6"	6	2"







VERIZON SITE NUMBER: 307653

BU #: **877107 FILL-IN / GREELY/GRE216**

> 151 OAK DRIVE, EATON, CO 80615

EXISTING 117'-6" MONOPOLE TOWER

				114	
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REVISION:


SHEET NUMBER:

C-8

Dual-mount

bracket assembled

JMA MX10 FRO 6/8 60 or FRO 4/6/8 40 or FIT 4 65 2x 10-Port Antennas + 2x RRHs

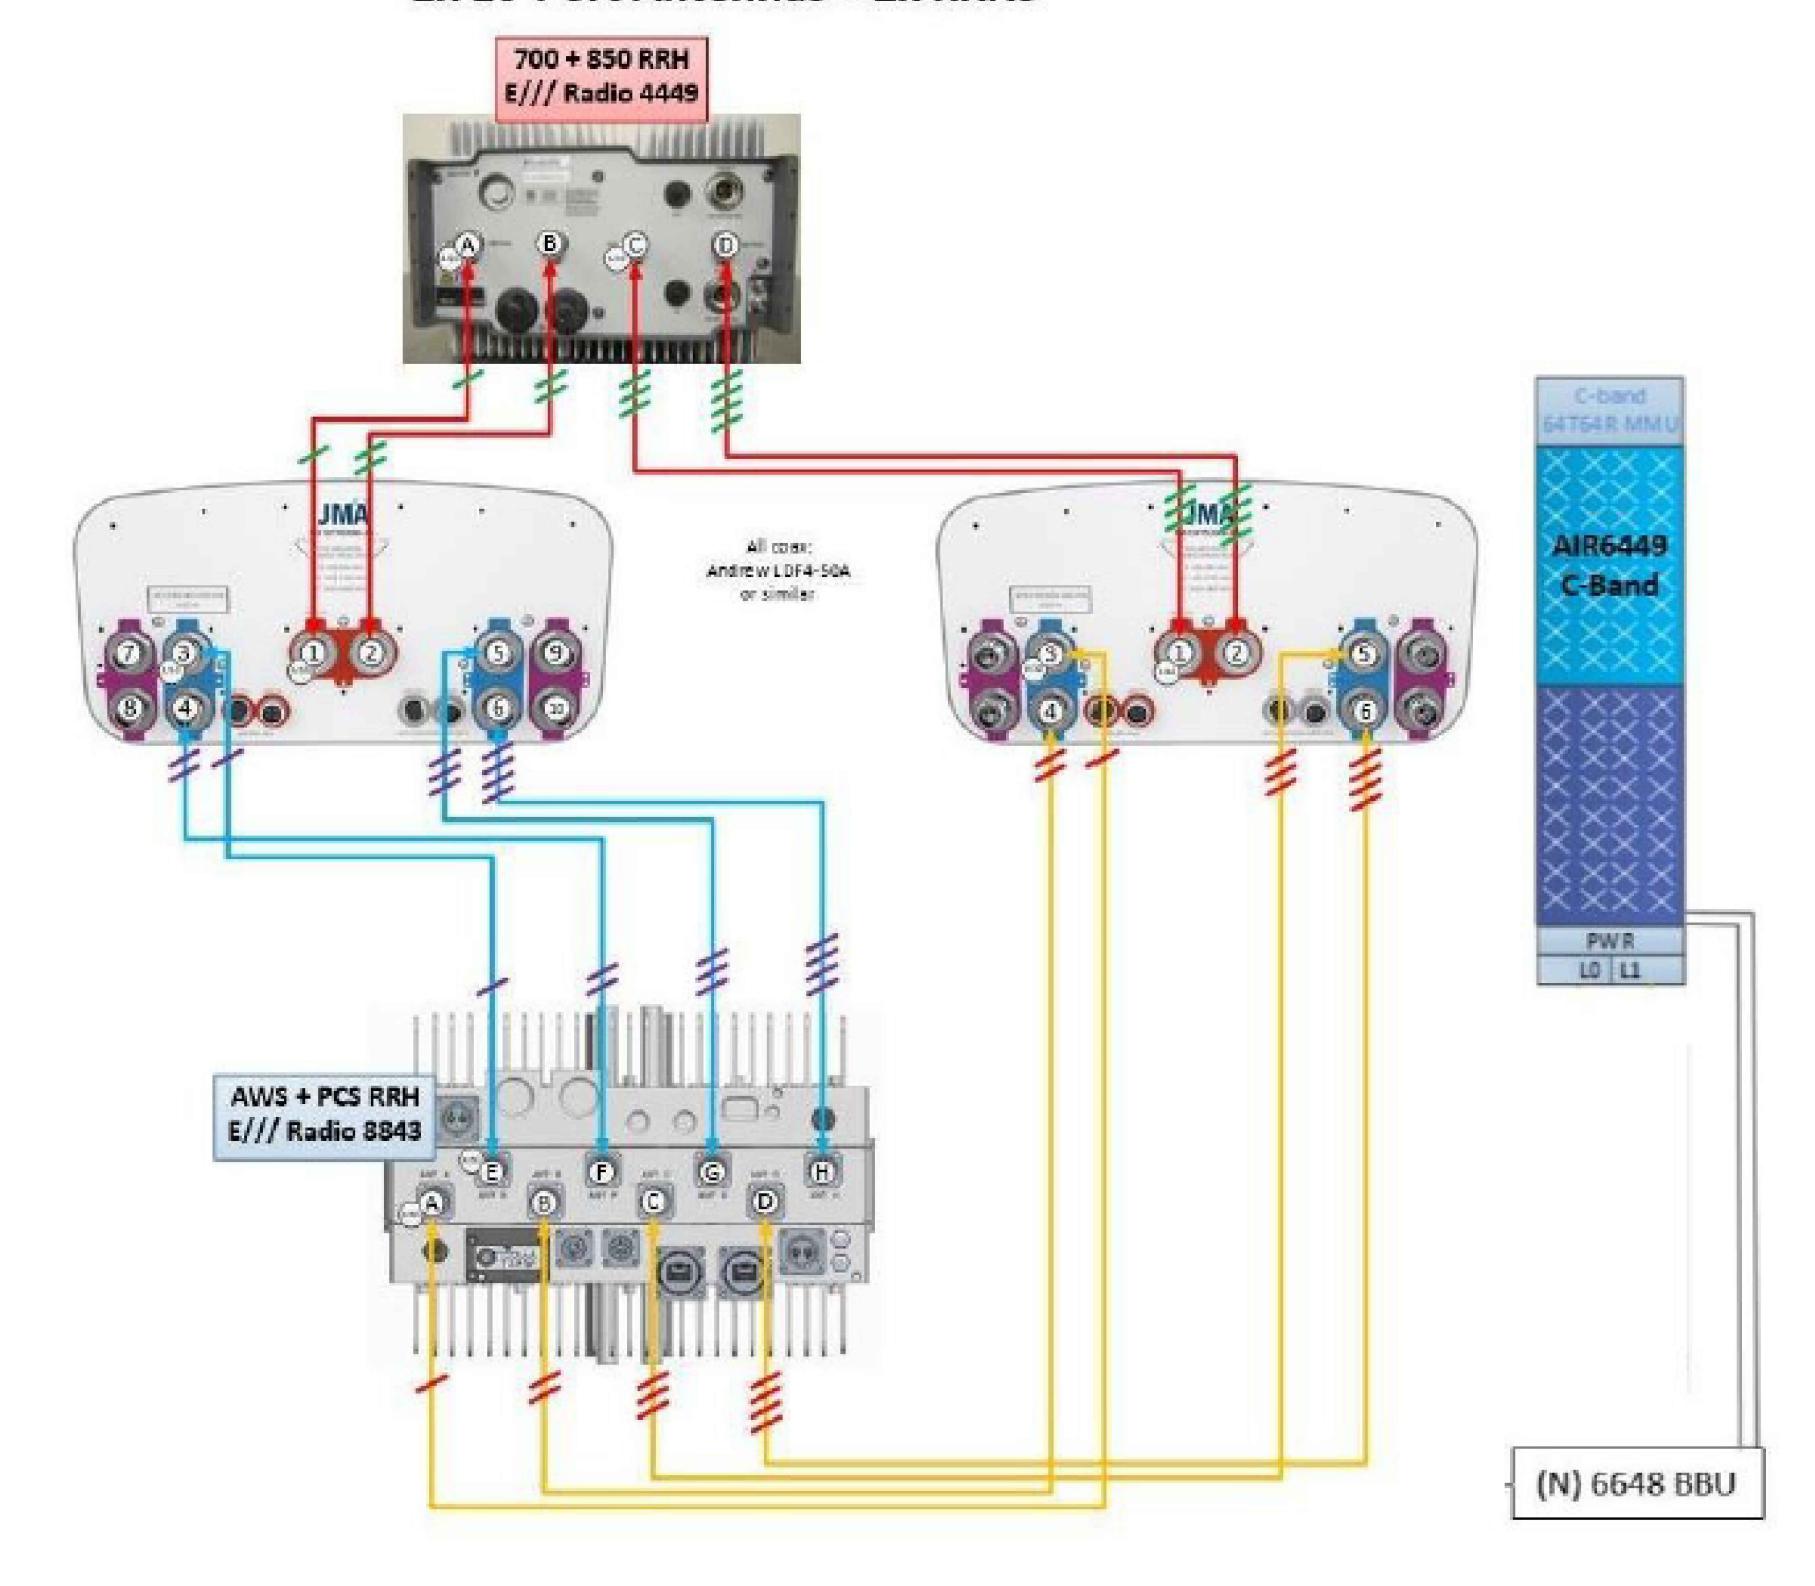







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> 151 OAK DRIVE, EATON, CO 80615

EXISTING 117'-6" MONOPOLE TOWER


ISSUED FOR:					
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3	03/30/2023	NPS	FINAL	AMT	
4	05/15/2023	SBA	FINAL	AMT	



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SHEET NUMBER:

C-9

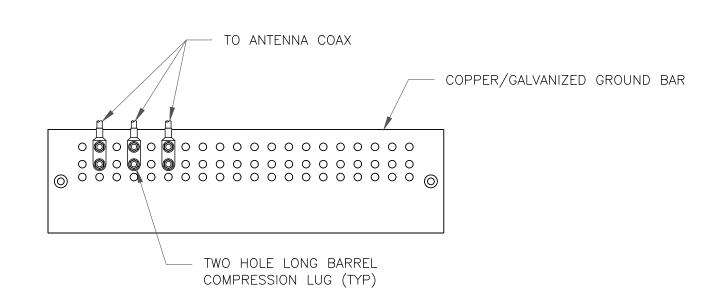


NOTES:

- 1. DOUBLING UP "OR STACKING" OF CONNECTIONS IS NOT PERMITTED.
- 2. EXTERIOR ANTIOXIDANT JOINT COMPOUND TO BE USED ON ALL EXTERIOR CONNECTIONS.
- 3. GROUND BAR SHALL NOT BE ISOLATED FROM TOWER. MOUNT DIRECTLY TO ANTENNA MOUNT STEEL.




SCALE: NOT TO SCALE

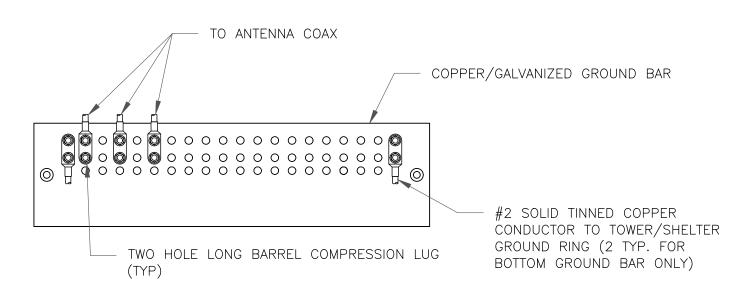

- 1. EXTERIOR ANTIOXIDANT JOINT COMPOUND TO BE USED ON ALL EXTERIOR CONNECTIONS.
- 2. GROUND BAR SHALL NOT BE ISOLATED FROM TOWER. MOUNT DIRECTLY TO TOWER STEEL (TOWER ONLY).
- 3. GROUND BAR SHALL BE ISOLATED FROM BUILDING OR SHELTER.







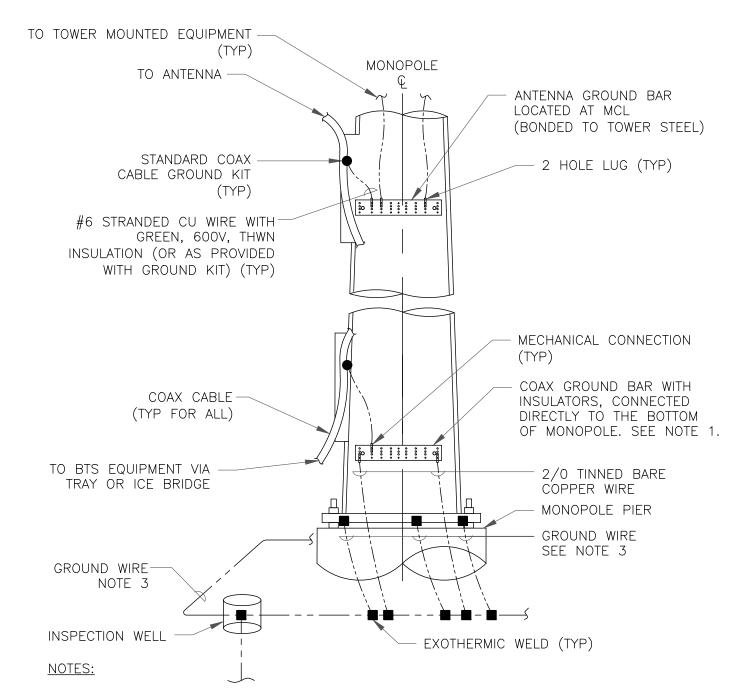


- 1. NUMBER OF GROUNDING BARS MAY VARY DEPENDING ON THE TYPE OF TOWER, ANTENNA LOCATIONS AND CONNECTION ORIENTATION. COAXIAL CABLES EXCEEDING 200 FEET ON THE TOWER SHALL HAVE GROUND KITS AT THE MIDPOINT. PROVIDE AS REQUIRED.
- 2. ONLY MECHANICAL CONNECTIONS ARE ALLOWED TO BE MADE TO CROWN CASTLE USA INC. TOWERS. ALL MECHANICAL CONNECTIONS SHALL BE TREATED WITH AN ANTI-OXIDANT COATING.
- 3. ALL TOWER GROUNDING SYSTEMS SHALL COMPLY WITH THE REQUIREMENTS OF THE RECOGNIZED EDITION OF ANSI/TIA 222 AND NFPA 780.




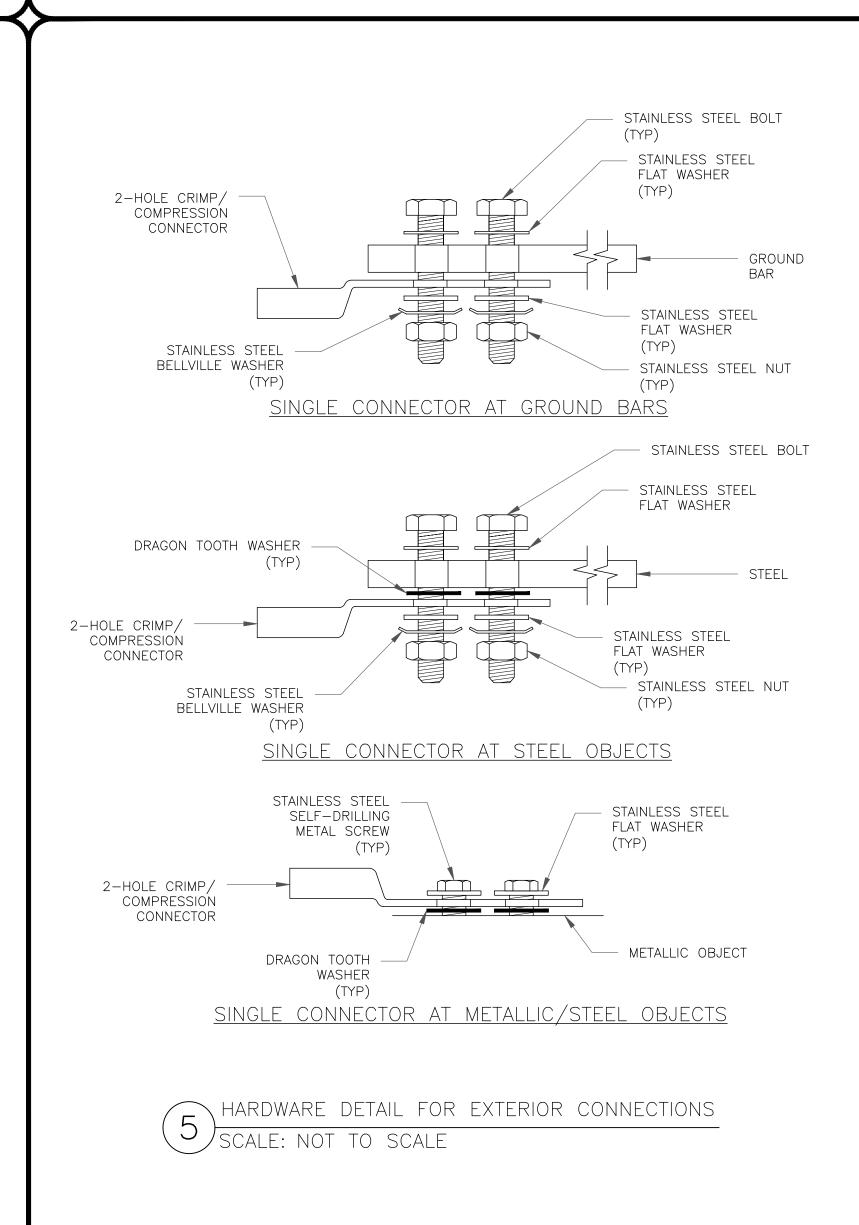

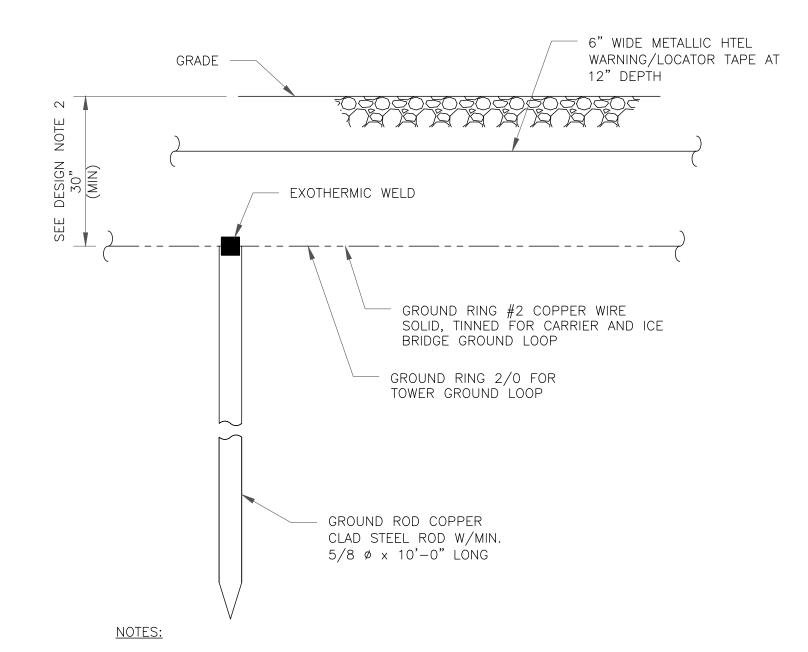

- 1. GROUND ROD SHALL BE DRIVEN VERTICALLY, NOT TO EXCEED 45 DEGREES FROM THE
- 2. GROUND WIRE SHALL BE MIN. 30" BELOW GRADE OR 6" BELOW FROST LINE. (WHICH EVER IS GREATER) AS PER N.E.C. ARTICLE 250-50(D)

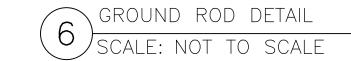

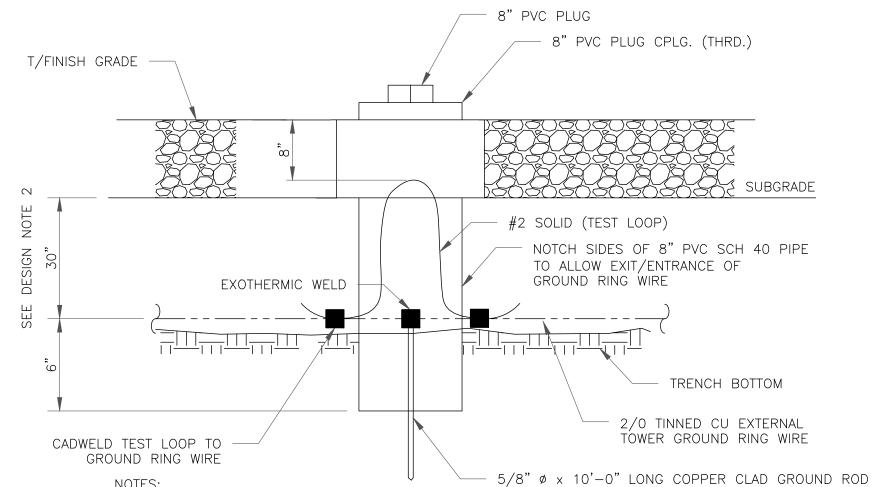

2. GROUND WIRE SHALL BE MIN. 30" BELOW GRADE OR 6" BELOW FROST LINE. (WHICH EVER IS GREATER) AS PER N.E.C. ARTICLE 250-50(D)

1. GROUND ROD SHALL BE DRIVEN VERTICALLY, NOT TO EXCEED 45 DEGREES FROM THE



SCHAUMBURG, IL 60173





1825 W. WALNUT HILL LANE, SUITE 120 IRVING, TEXAS 75038

VERIZON SITE NUMBER: 307653

BU #: **877107** FILL-IN / GREELY/GRE216

> 151 OAK DRIVE, EATON, CO 80615


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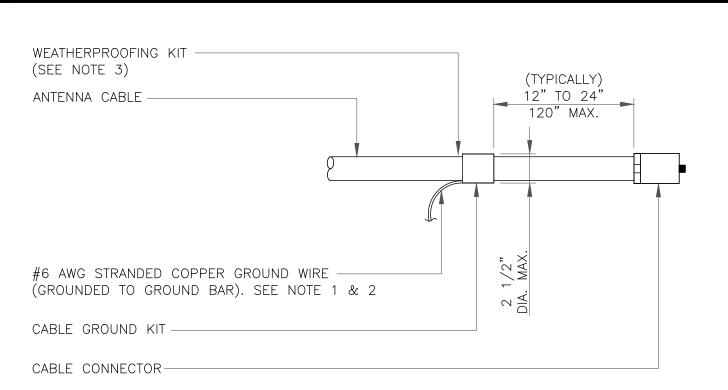


NOTE:

- 1. ERICO EXOTHERMIC "MOLD TYPES" SHOWN HERE ARE EXAMPLES. CONSULT WITH CONSTRUCTION MANAGER FOR SPECIFIC
- MOLDS TO BE USED FOR THIS PROJECT.

 2. MOLD TYPE ONLY TO BE USED BELOW GRADE WHEN CONNECTING GROUND RING TO GROUND ROD.


CADWELD GROUNDING CONNECTIONS SCALE: NOT TO SCALE

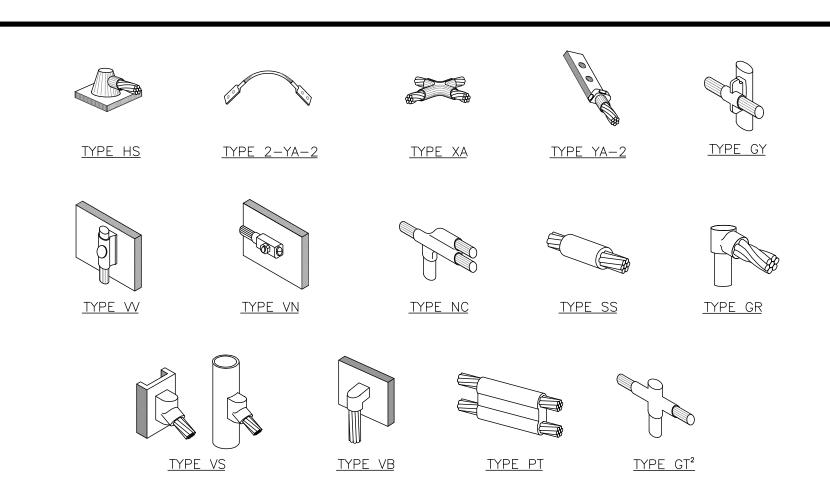

NOTES

- DO NOT INSTALL CABLE GROUND KIT AT A BEND AND ALWAYS DIRECT GROUND WIRE DOWN TO GROUND BAR.
- 2. GROUNDING KIT SHALL BE TYPE AND PART NUMBER AS SUPPLIED OR RECOMMENDED BY CABLE MANUFACTURER.
- 3. WEATHER PROOFING SHALL BE TWO-PART TAPE KIT, COLD SHRINK SHALL NOT BE USED.


3 CABLE GROUND KIT CONNECTION SCALE: NOT TO SCALE

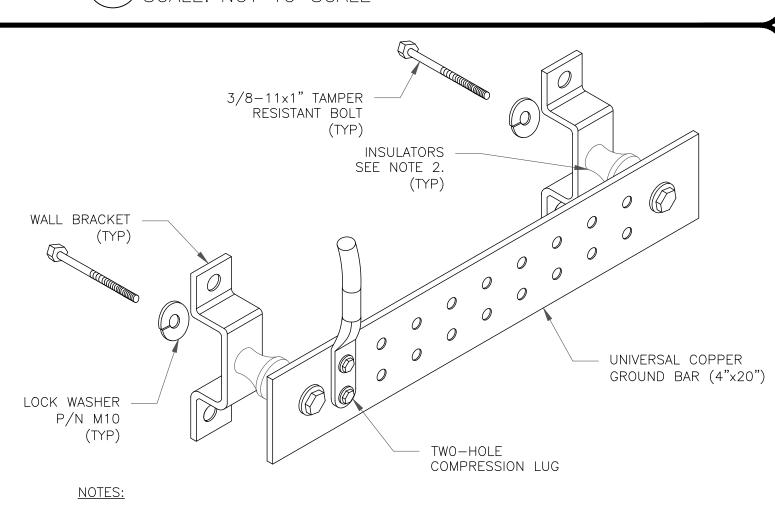

1. DOWN LEAD (HOME RUN) CONDUCTORS ARE <u>NOT</u> TO BE INSTALLED ON CROWN CASTLE USA INC. TOWER, PER THE GROUNDING DOWN CONDUCTOR POLICY QAS—STD—10091. NO MODIFICATION OR DRILLING TO TOWER STEEL IS ALLOWED IN ANY FORM OR FASHION, CAD—WELDING ON THE TOWER AND/OR IN THE AIR ARE NOT PERMITTED.


2. OMIT INSULATOR WHEN MOUNTING TO TOWER STEEL OR PLATFORM STEEL USE INSULATORS WHEN ATTACHING TO BUILDING OR SHELTERS.

6 GROUND BAR DETAIL SCALE: NOT TO SCALE

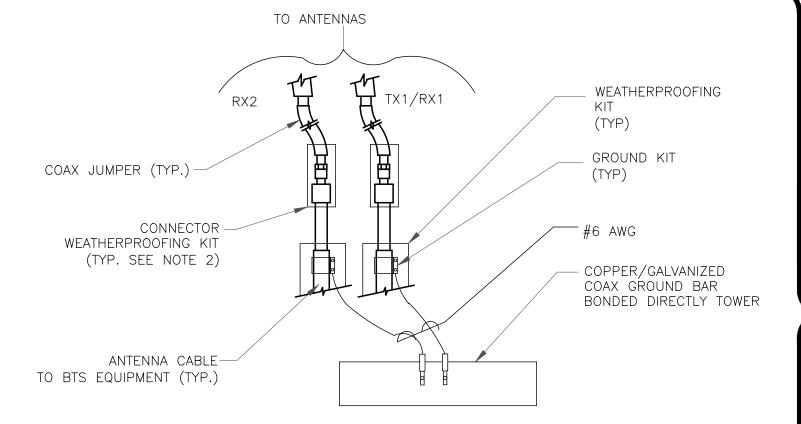


- NOTES:
- 1. DO NOT INSTALL CABLE GROUND KIT AT A BEND AND ALWAYS DIRECT GROUND WIRE DOWN TO ANTENNA GROUND BAR.
- 2. WEATHER PROOFING SHALL BE TWO-PART TAPE KIT. COLD SHRINK SHALL NOT BE USED.

GROUND CABLE CONNECTION
SCALE: NOT TO SCALE

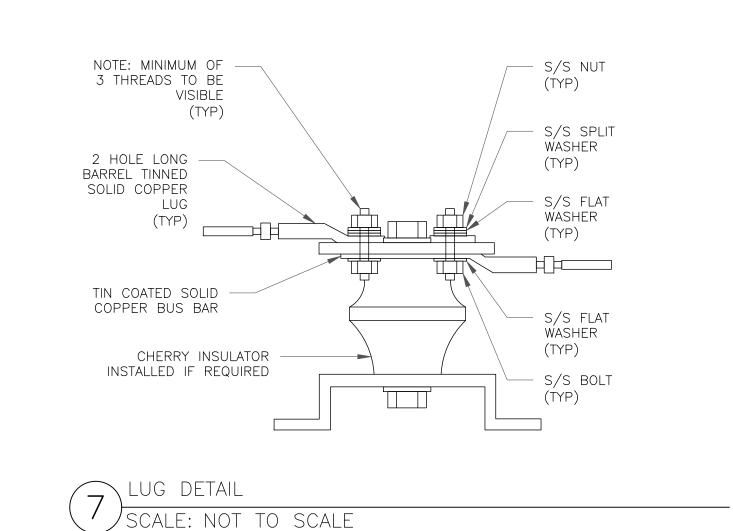


WIRE SIZE BURNDY LUG BOLT SIZE 3/8" - 16 NC S 2 BOLT #6 AWG GREEN INSULATED YA6C-2TC38 #2 AWG SOLID TINNED YA3C-2TC38 3/8" - 16 NC S 2 BOLT #2 AWG STRANDED YA2C-2TC38 3/8" - 16 NC S 2 BOLT 3/8" - 16 NC S 2 BOLT #2/0 AWG STRANDED YA26-2TC38 1/2" - 16 NC S 2 BOLT #4/0 AWG STRANDED YA28-2N

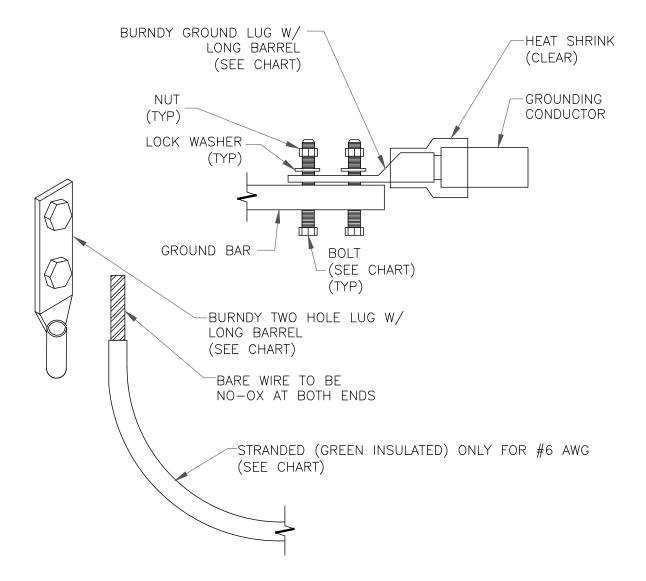


NOTES:

- 1. ALL GROUNDING LUGS ARE TO BE INSTALLED PER MANUFACTURER'S SPECIFICATIONS.
 ALL HARDWARE BOLTS, NUTS, LOCK WASHERS SHALL BE STAINLESS STEEL. ALL
 HARDWARE ARE TO BE AS FOLLOWS: BOLT, FLAT WASHER, GROUND BAR, GROUND LUG,
 FLAT WASHER AND NUT.
- MECHANICAL LUG CONNECTION
 SCALE: NOT TO SCALE

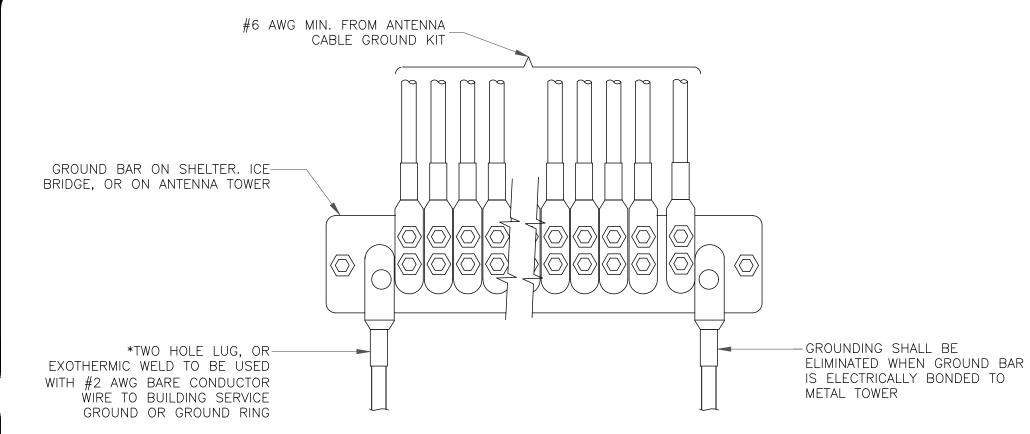

 $(5) \frac{\text{GROUNDWIRE INSTALLATION}}{\text{SCALE: NOT TO SCALE}}$

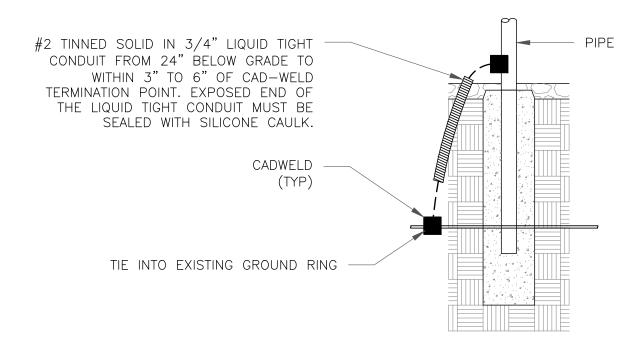

8 TRANSITIONING GROUND DETAIL SCALE: NOT TO SCALE







1825 W. WALNUT HILL LANE, SUITE 120 IRVING, TEXAS 75038

VERIZON SITE NUMBER: 307653

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> 151 OAK DRIVE, EATON, CO 80615

EXISTING 117'-6" MONOPOLE TOWER

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2011				



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SHEET NUMBER:

2

4519588 09/03/2019 08:44 AM Page 13 of 17

EXHIBIT "C-1" TO FIRST MODIFICATION TO GRANT OF EASEMENT

[Description of Tower Area]

A PARCEL OF LAND LOCATED IN THE NORTHWEST QUARTER OF SECTION 6, TOWNSHIP 6 NORTH, RANGE 65 WEST OF THE SIXTH PRINCIPAL MERIDIAN, COUNTY OF WELD, STATE OF COLORADO, BEING MORE PARTICULARLY DESCRIBED AS FOLLOWS:

BASIS OF BEARINGS: BEARINGS ARE BASED UPON THE NORTH LINE OF THE NW1/4, SEC 6, T6N, R65W, OF THE 6TH P.M., SAID LINE IS ASSUMED TO BEAR SOUTH 88°15'57" EAST A DISTANCE OF 2651.32 FEET BETWEEN A FOUND MAG NAIL FOUND AT THE NW CORNER SAID NW1/4 AND A 3.25" ALUMINUM CAP STAMPED PLS 10855 FOUND AT THE N1/4 CORNER SAID SECTION 6.

COMMENCING AT THE NORTH QUARTER OF SAID SECTION 6, A FOUND 3.25" ALUMINUM CAP STAMPED, P.L.S. NO. 10855;

THENCE N88°15'57"W ALONG THE NORTH LINE OF SAID NORTHWEST QUARTER, A DISTANCE OF 905.44 FEET;

THENCE DEPARTING SAID NORTH LINE, S00°00'00"W, A DISTANCE OF 652.03 FEET; THENCE S22°55'50"E, A DISTANCE OF 15.00 FEET TO THE POINT OF BEGINNING;

THENCE CONTINUING \$22°55'50"E, 30.00 FEET;

THENCE S67°04'10"W, 20.00 FEET;

THENCE N22°55'50"W, 30.00;

THENCE N67°04'10"E 20.00 FEET TO THE POINT OF BEGINNING.

CONTAINING +\-600 SQUARE FEET OR +\-0.014 ACRES MORE OR LESS.

Site Name: Fill-In /Greely/GRE216

4519588 09/03/2019 08:44 AM Page 14 of 17

EXHIBIT "C-2" TO FIRST MODIFICATION TO GRANT OF EASEMENT

[Description of Access and (Guy and/or Utility) Areas]

15-FOOT ACCESS AND UTILITY AREA:

A PARCEL OF LAND LOCATED IN THE NORTHWEST QUARTER OF SECTION 6, TOWNSHIP 6 NORTH, RANGE 65 WEST OF THE SIXTH PRINCIPAL MERIDIAN, COUNTY OF WELD, STATE OF COLORADO, BEING MORE PARTICULARLY DESCRIBED AS FOLLOWS:

COMMENCING AT THE NORTH QUARTER OF SAID SECTION 6, A FOUND 3.25" ALLOW CAP STAMPED, P.L.S. NO. 10855;

BASIS OF BEARINGS: BEARINGS ARE BASED UPON THE NORTH LINE OF THE NW1/4, SEC 6, T6N, R65W, OF THE 6TH P.M., SAID LINE IS ASSUMED TO BEAR SOUTH 88°15'57" EAST A DISTANCE OF 2651.32 FEET BETWEEN A FOUND MAG NAIL FOUND AT THE NW CORNER SAID NW1/4 AND A 3.25" ALUMINUM CAP STAMPED PLS 10855 FOUND AT THE N1/4 CORNER SAID SECTION 6.

THENCE NORTH 88°15'57" WEST ALONG THE NORTH LINE OF SAID NORTHWEST QUARTER A DISTANCE OF 795.56 FEET;

THENCE DEPARTING SAID NORTH LINE SOUTH 00°00'00" WEST A DISTANCE OF 693.86 FEET;

THENCE SOUTH 61°46'12" WEST A DISTANCE OF 20.92 FEET;

THENCE SOUTH 65°08'48" WEST A DISTANCE OF 60.86 FEET;

THENCE NORTH 22°55'50" WEST A DISTANCE OF 55.17 FEET TO THE POINT OF BEGINNING;

THENCE SOUTH 67°04'10" WEST A DISTANCE OF 1.89 FEET;

THENCE NORTH 22°55'50" WEST A DISTANCE OF 33.18 FEET;

THENCE NORTH 67°04'10" EAST A DISTANCE OF 15.00 FEET;

THENCE SOUTH 22°55'50" EAST A DISTANCE OF 33.18 FEET;

THENCE SOUTH 67°04'10" WEST A DISTANCE OF 13.11 FEET TO THE POINT OF BEGINNING.

CONTAINING ±498 SQUARE FEET OR ±0.011 ACRES, MORE OR LESS.

Site Name: Fill-In /Greely/GRE216

4519588 09/03/2019 08:44 AM Page 15 of 17

20 FOOT WIDE ACCESS AND UTILITY AREA:

A 20 FOOT WIDE TOWER ACCESS EASEMENT LOCATED IN THE NORTHWEST QUARTER OF SECTION 6, TOWNSHIP 6 NORTH, RANGE 65 WEST OF THE SIXTH PRINCIPAL MERIDIAN, COUNTY OF WELD, STATE OF COLORADO, BEING 10 FEET ON EACH SIDE OF THE FOLLOWING CENTERLINE:

COMMENCING AT THE NORTH QUARTER OF SAID SECTION 6, A FOUND 3.25" ALLOW CAP STAMPED, P.L.S. NO. 10855;

THENCE N88°15'57"W ON THE NORTH LINE OF SAID NORTHWEST QUARTER, 795.56 FEET;

THENCE DEPARTING SAID NORTH LINE S00°00'00"W, 693.86 FEET TO THE POINT OF BEGINNING;

THENCE S61°46'12"W, 20.92 FEET;

THENCE S65°08'48"W. 60.86 FEET:

THENCE N22°55'50"W, 55.17 FEET TO THE POINT OF TERMINUS.

CONTAINING A COMPUTED AREA OF +\-2,737.93 SQUARE FEET MORE OR LESS.

Site Name: Fill-In /Greely/GRE216

4519588 09/03/2019 08:44 AM Page 16 of 17

EXHIBIT "C-3" TO FIRST MODIFICATION TO GRANT OF EASEMENT

[Description of Additional Easement Area]

A PARCEL OF LAND LOCATED IN THE NORTHWEST QUARTER OF SECTION 6, TOWNSHIP 6 NORTH, RANGE 65 WEST OF THE SIXTH PRINCIPAL MERIDIAN, COUNTY OF WELD, STATE OF COLORADO, BEING MORE PARTICULARLY DESCRIBED AS FOLLOWS:

COMMENCING AT THE NORTH QUARTER OF SAID SECTION 6, A FOUND 3.25" ALUMINUM CAP STAMPED, P.L.S. NO. 10855;

BASIS OF BEARINGS: BEARINGS ARE BASED UPON THE NORTH LINE OF THE NW1/4, SEC 6, T6N, R65W, OF THE 6TH P.M., SAID LINE IS ASSUMED TO BEAR SOUTH 88°15'57" EAST A DISTANCE OF 2651.32 FEET BETWEEN A FOUND MAG NAIL FOUND AT THE NW CORNER SAID NW1/4 AND A 3.25" ALUMINUM CAP STAMPED PLS 10855 FOUND AT THE N1/4 CORNER SAID SECTION 6.

THENCE N88°15'57"W ALONG THE NORTH LINE OF SAID NORTHWEST QUARTER, A DISTANCE OF 905.44 FEET;

THENCE DEPARTING SAID NORTH LINE S00°00'00"W, A DISTANCE OF 652.03 FEET TO THE POINT OF BEGINNING;

THENCE CONTINUING S22°55'50"E, A DISTANCE OF 15.00 FEET;

THENCE S67°04'10"W, A DISTANCE OF 20.00 FEET;

THENCE N22°55'50W, A DISTANCE OF 15.00 FEET;

THENCE N67°04'10"E, A DISTANCE OF 20.00 FEET TO THE POINT OF BEGINNING.

CONTAINING +\-300 SQUARE FEET OR +\-0.007 ACRES MORE OR LESS.

Site Name: Fill-In /Greely/GRE216

4519588 09/03/2019 08:44 AM Page 17 of 17

EXHIBIT "C-4" TO FIRST MODIFICATION TO GRANT OF EASEMENT

[Description of Easement Area, as expanded]

A PARCEL OF LAND LOCATED IN THE NORTHWEST QUARTER OF SECTION 6, TOWNSHIP 6 NORTH, RANGE 65 WEST OF THE SIXTH PRINCIPAL MERIDIAN, COUNTY OF WELD, STATE OF COLORADO, BEING MORE PARTICULARLY DESCRIBED AS FOLLOWS:

BASIS OF BEARINGS: BEARINGS ARE BASED UPON THE NORTH LINE OF THE NW1/4, SEC 6, T6N, R65W, OF THE 6TH P.M., SAID LINE IS ASSUMED TO BEAR SOUTH 88°15'57" EAST A DISTANCE OF 2651.32 FEET BETWEEN A FOUND MAG NAIL FOUND AT THE NW CORNER SAID NW1/4 AND A 3.25" ALUMINUM CAP STAMPED PLS 10855 FOUND AT THE N1/4 CORNER SAID SECTION 6.

COMMENCING AT THE NORTH QUARTER OF SAID SECTION 6, A FOUND 3.25" ALUMINUM CAP STAMPED, P.L.S. NO. 10855;

THENCE N88°15'57"W ON THE NORTH LINE OF SAID NORTHWEST QUARTER, A DISTANCE OF 905.44 FEET;

THENCE DEPARTING SAID NORTH LINE S00°00'00"W, A DISTANCE OF 652.03 FEET TO THE POINT OF BEGINNING;

THENCE S22°55'50"E, A DISTANCE OF 45.00 FEET;

THENCE S67°04'10"W, A DISTANCE OF 20.00 FEET;

THENCE N22°55'50"W, A DISTANCE OF 45.00 FEET;

THENCE N67°04'10"E, A DISTANCE OF 20.00 FEET TO THE POINT OF BEGINNING.

CONTAINING +\-900 SQUARE FEET OR +\-0.021 ACRES MORE OR LESS.

The legal descriptions set forth on Exhibits C above were prepared by: Power Surveying Company, Inc. 720 W. 84th Avenue, Suite 240 Thornton, CO 80260 (303) 702-1617

Site Name: Fill-In /Greely/GRE216